

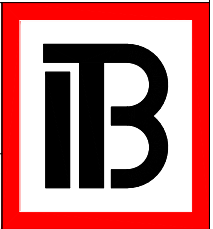
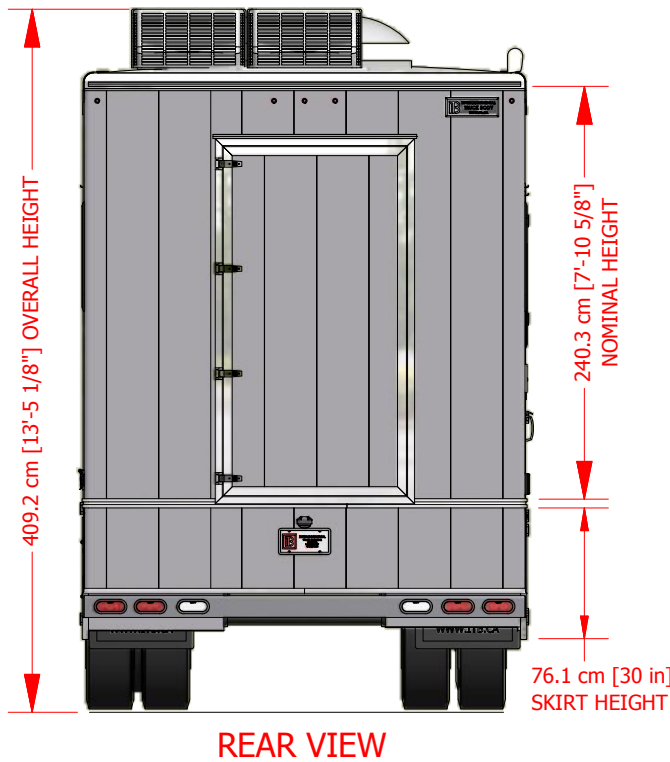
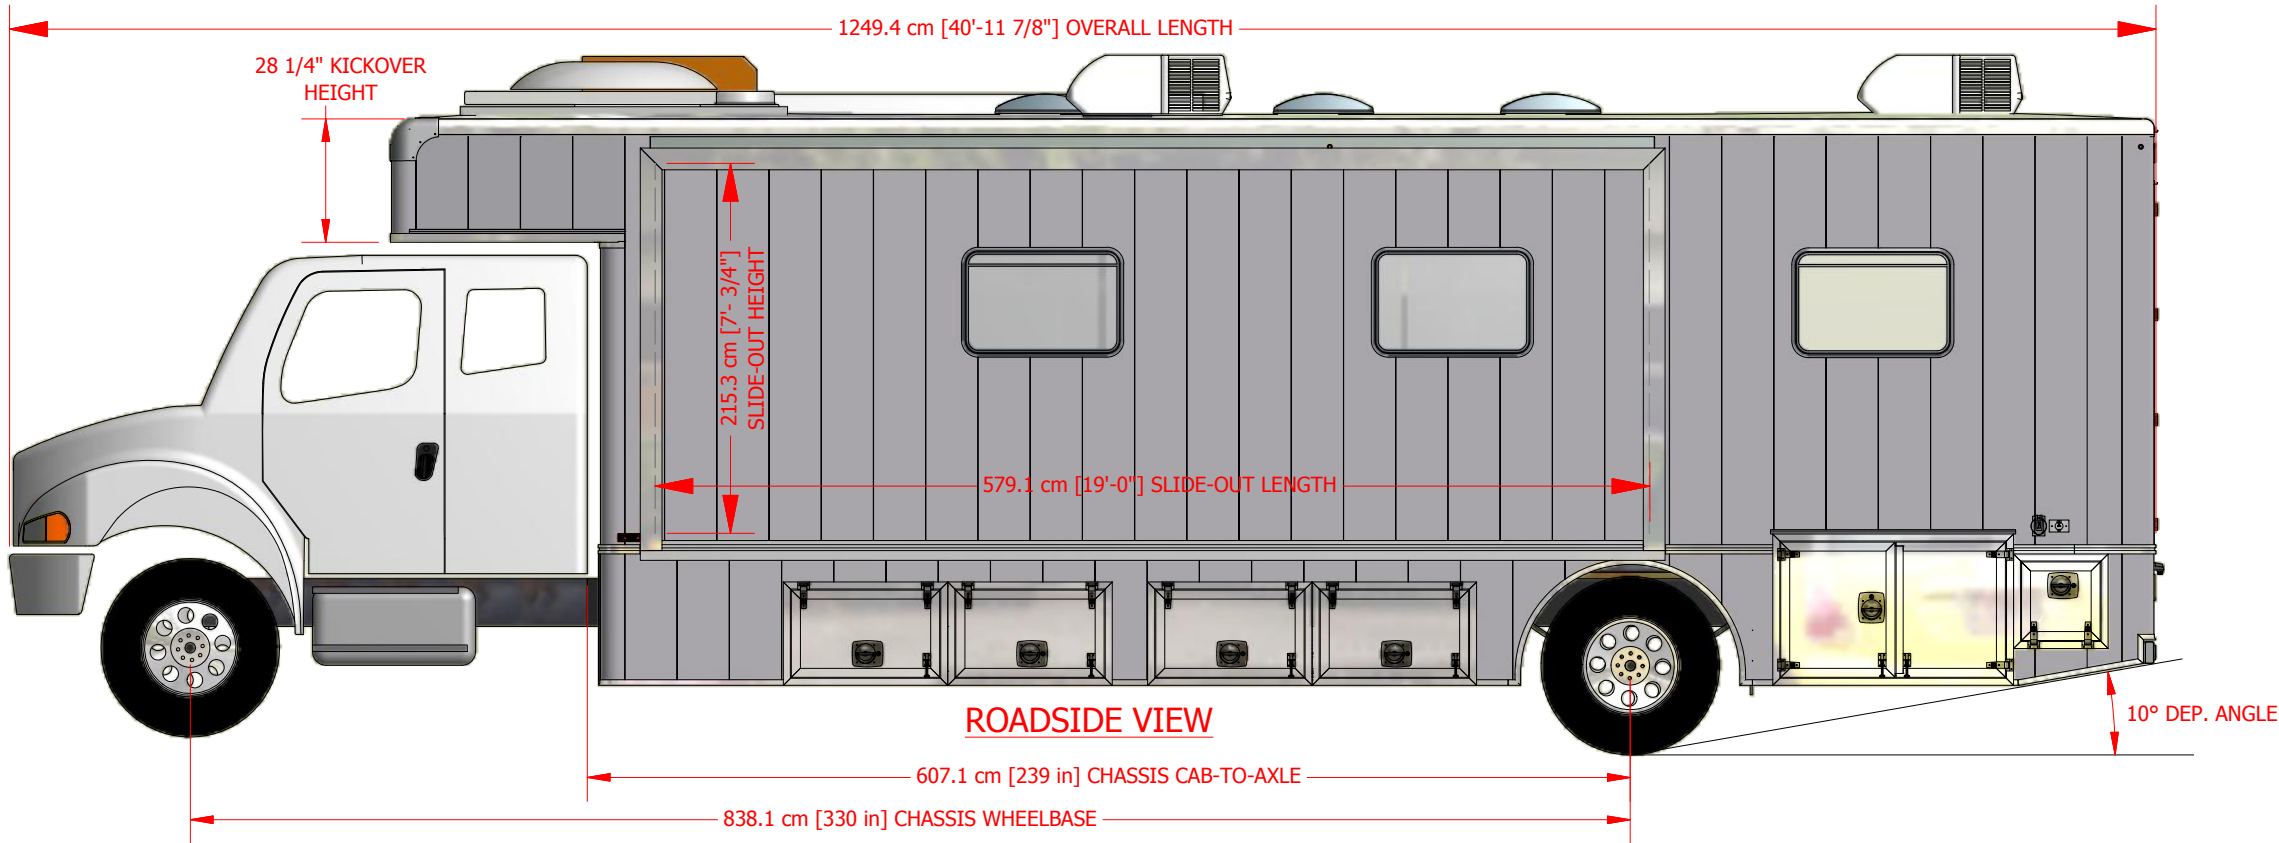


MOBILE MEDICAL VAN
ISO VIEW #1

MOBILE MEDICAL VAN
ISO VIEW #2

UNITS	SCALE	TITLE	INTERCONTINENTAL TRUCK BODY COALDALE, AB SURREY, BC 1-800-661-1030 1-888-819-2639 www.ITB.ca				
AS NOTED	AS NOTED						
DRAWN	DATE	CUSTOMER	STATION	ITB WORK ORDER	SHEET NO	REV	
MVB	2015-05-14						
CHECKED	DATE	UNIVERSITY OF ALBERTA	PRESENTATION	-	1 OF 10	1	

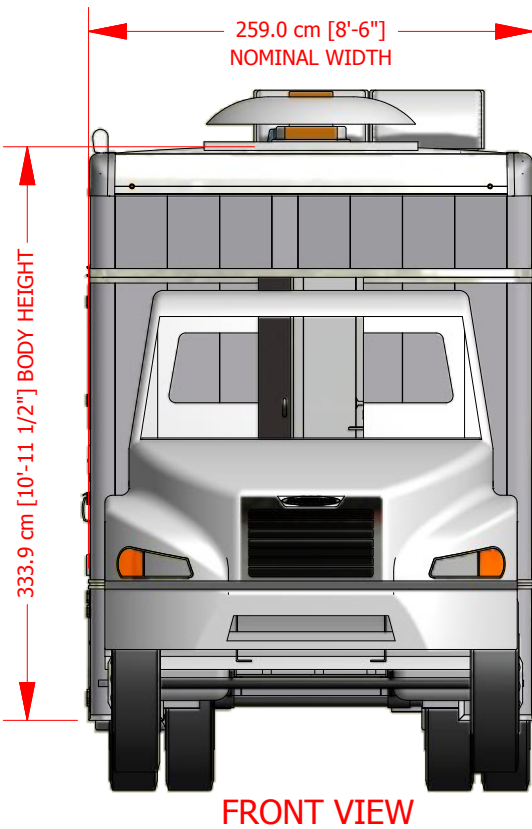





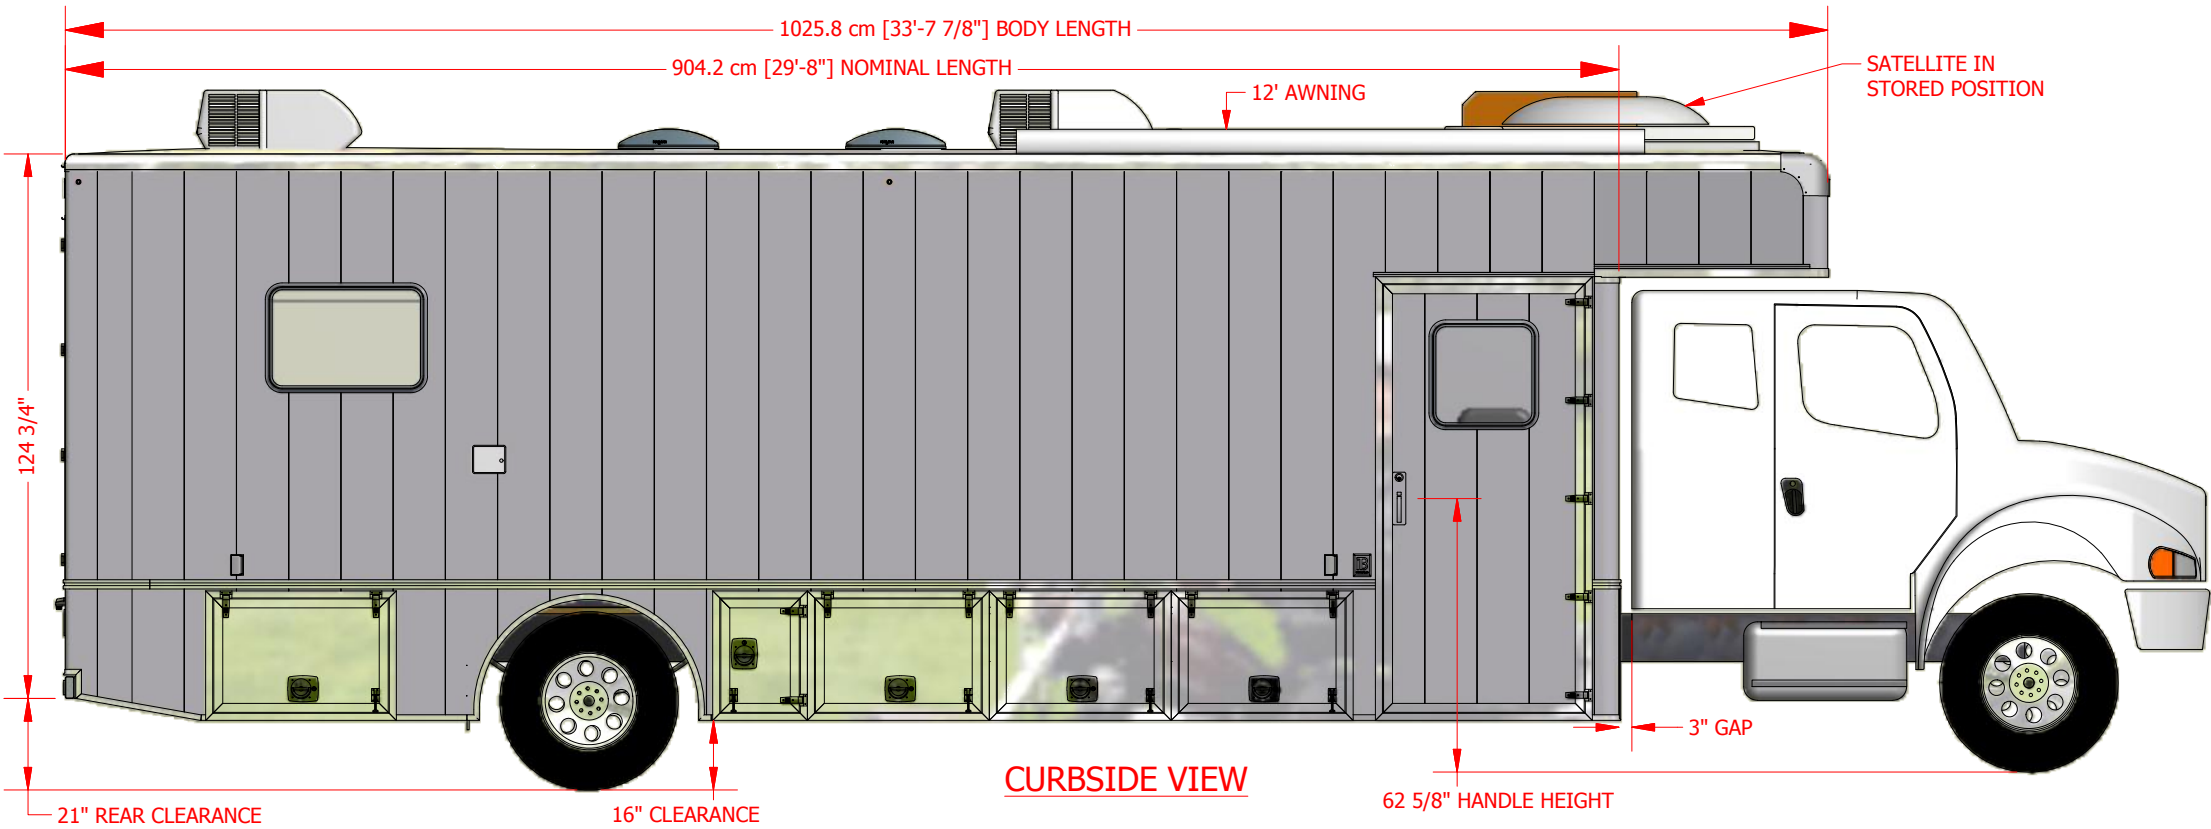


NOTES:

- 1. ALL DIMENSIONS ARE APPROXIMATE AND ARE DEPENDANT ON CHASSIS DIMENSIONS.
- 2.
- 3.
- 4.
- 5.


UNITS	SCALE	TITLE	INTERCONTINENTAL TRUCK BODY			
AS NOTED	AS NOTED					
DRAWN	DATE	CUSTOMER	COALDALE, AB SURREY, BC			
MVB	2015-05-14		1-800-661-1030 1-888-819-2639			
CHECKED	DATE	STATION	www.ITB.ca			
			ITB WORK ORDER SHEET NO REV			
		UNIVERSITY OF ALBERTA	EXTERIOR	-	2 OF 10	1

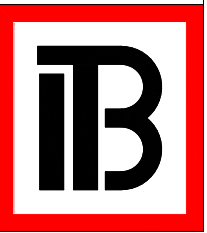

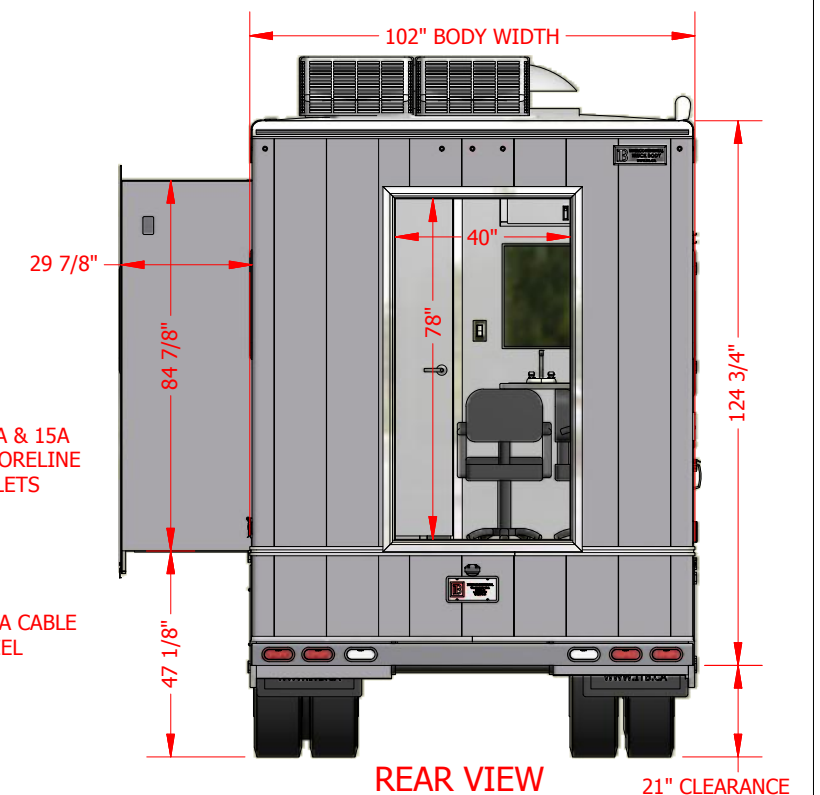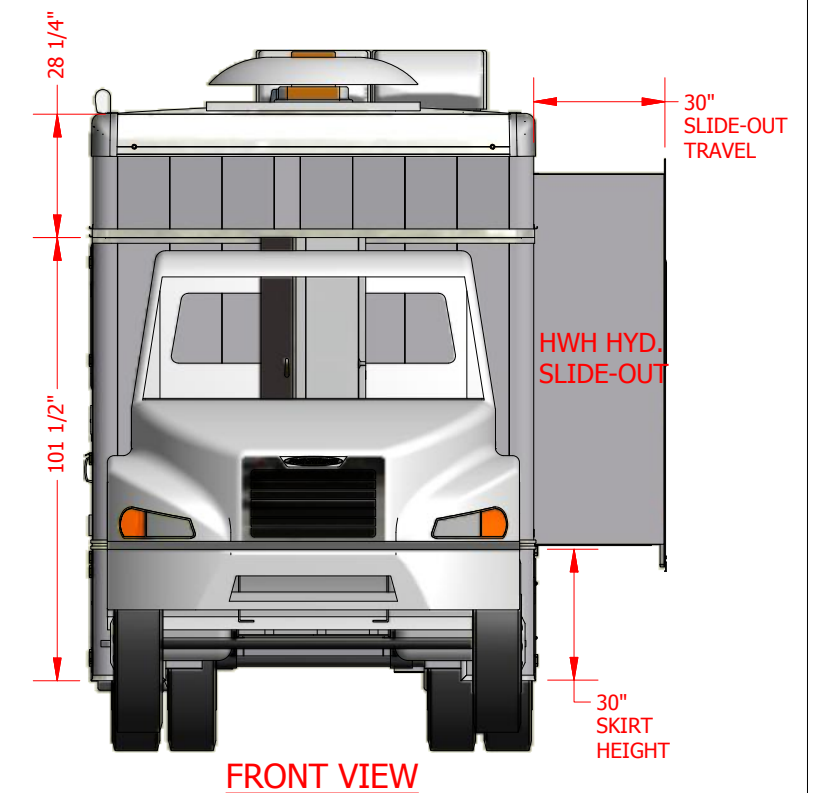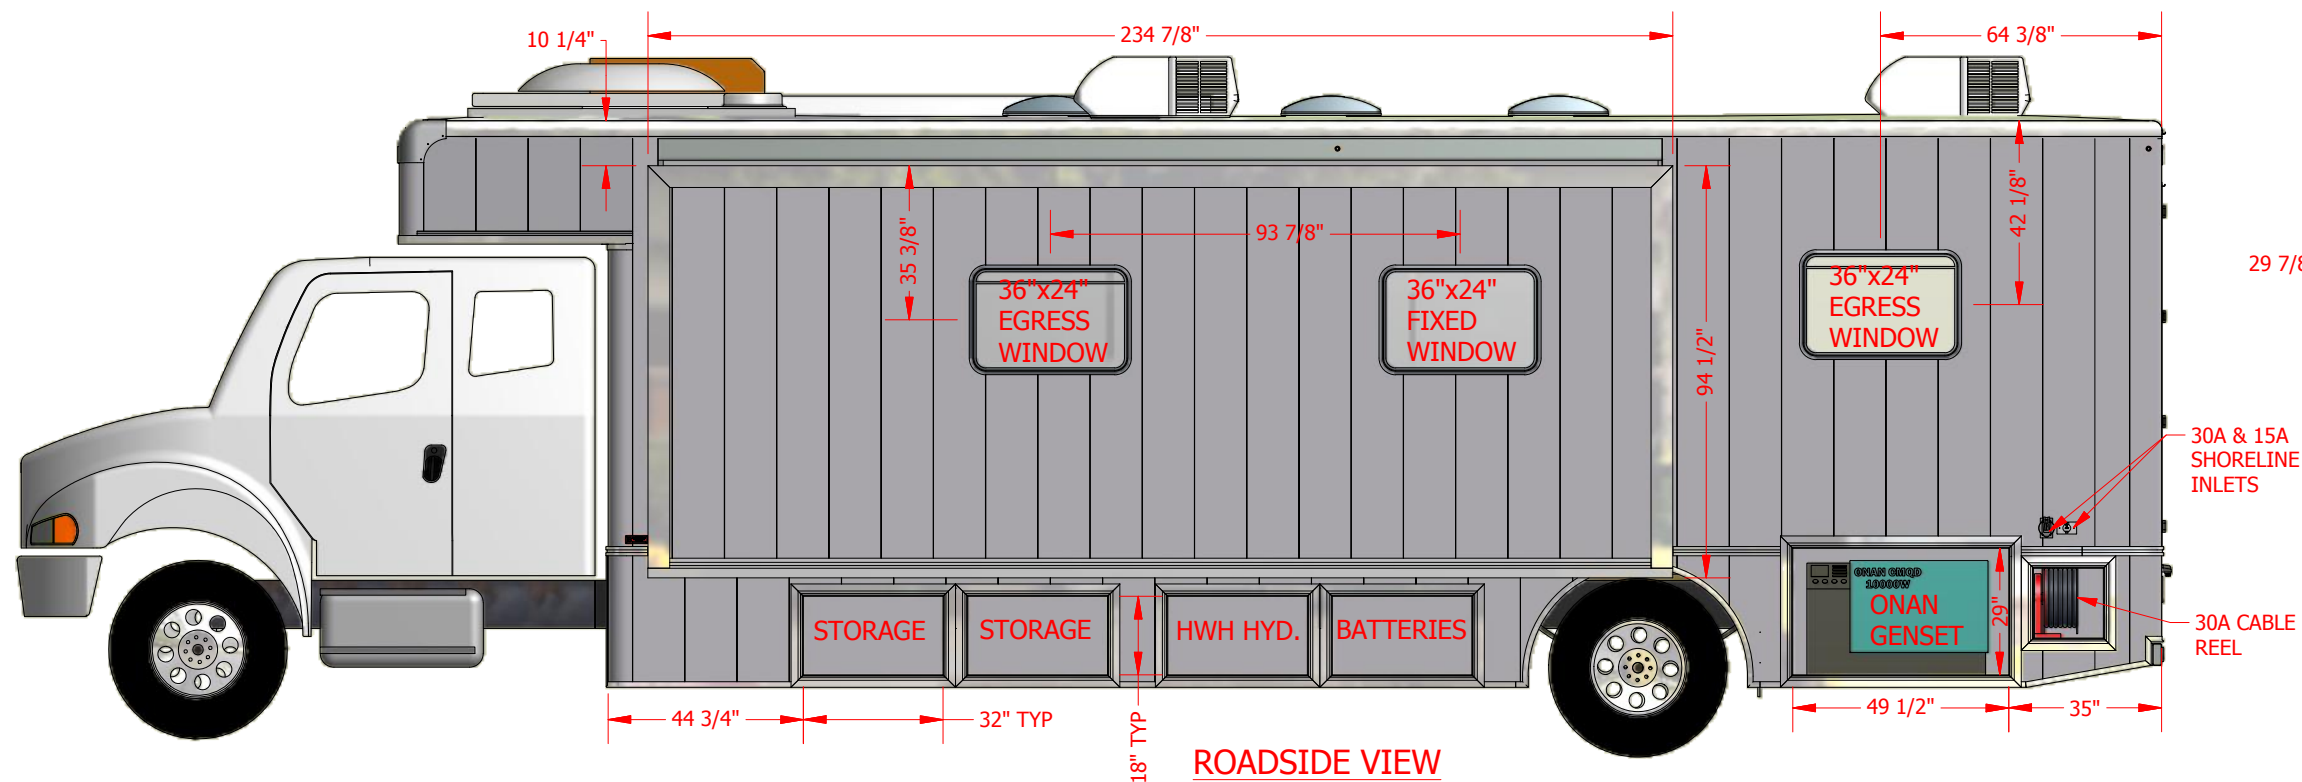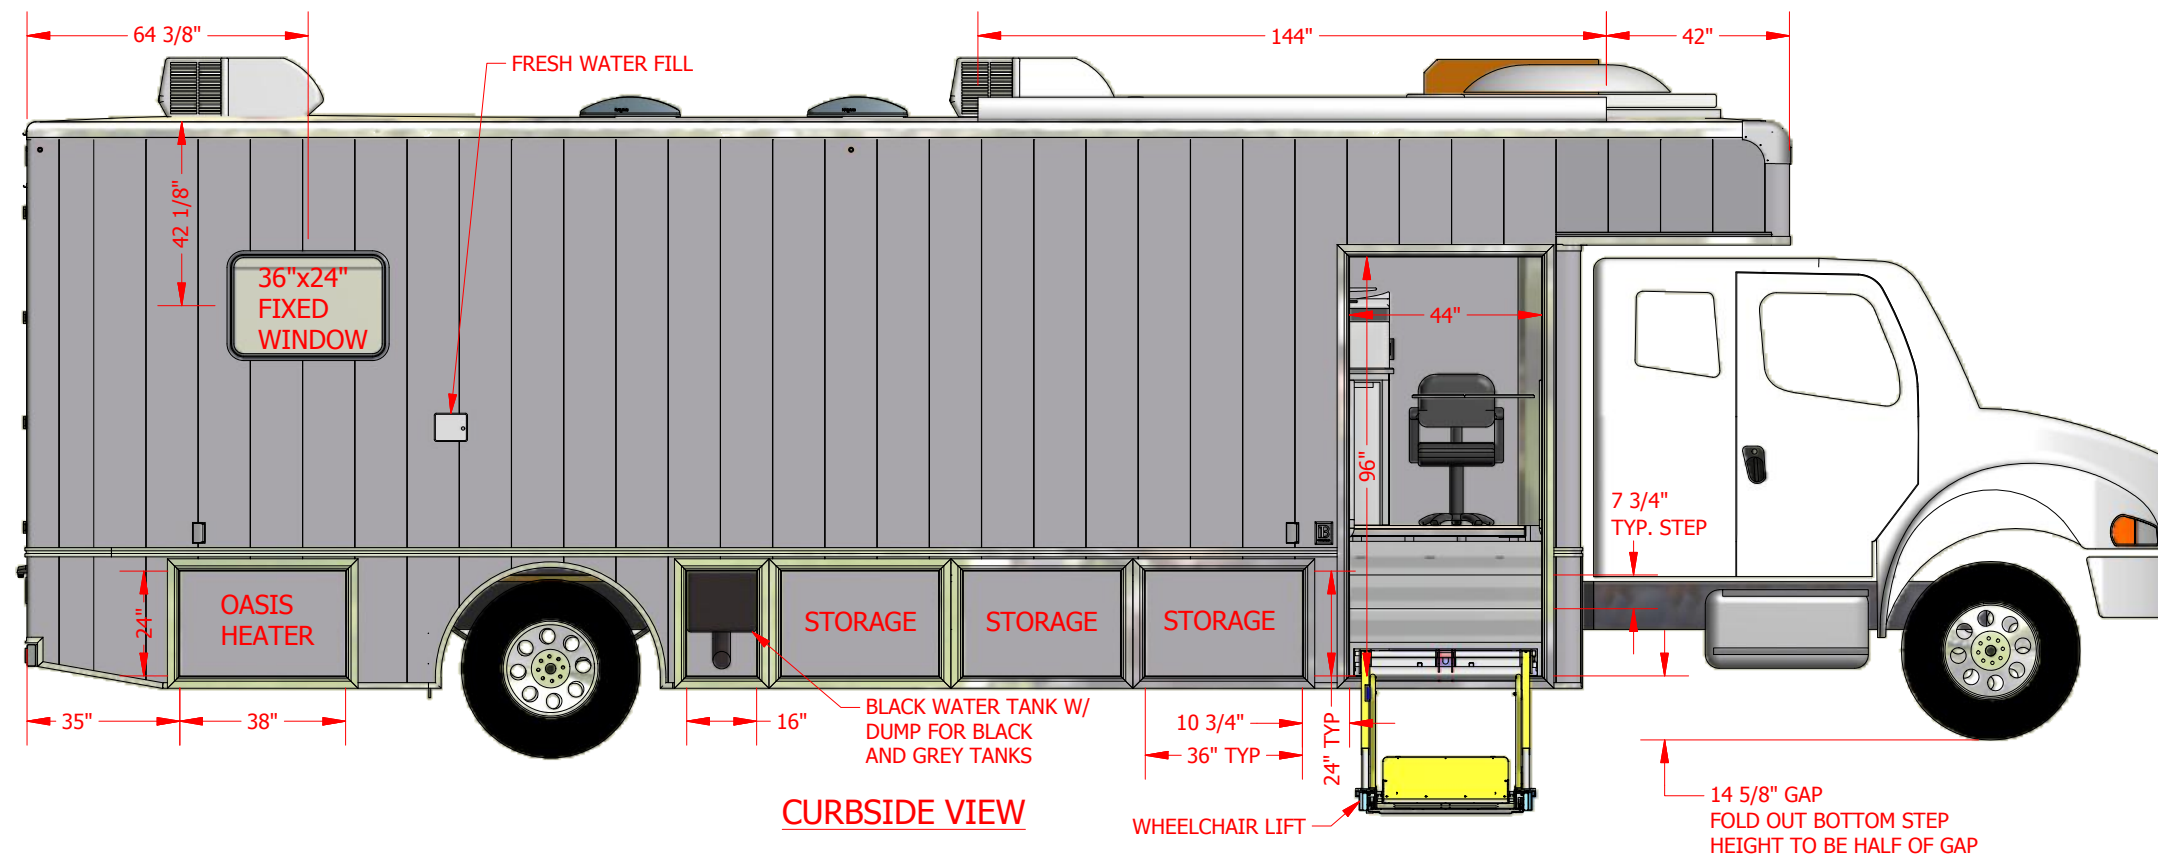


NOTES:

1. ALL DIMENSIONS ARE APPROXIMATE AND ARE DEPENDANT ON CHASSIS DIMENSIONS.
- 2.
- 3.
- 4.
- 5.

UNITS AS NOTED	SCALE AS NOTED	TITLE 29'8"L x 7'10"IDH x 8'6"W FREIGHTLINER M2-106 330" WB, (239"CA)	INTERCONTINENTAL TRUCK BODY COALDALE, AB SURREY, BC 1-800-661-1030 1-888-819-2639 www.ITB.ca				
DRAWN MVB	DATE 2015-05-14						
CHECKED	DATE	CUSTOMER UNIVERSITY OF ALBERTA	STATION EXTERIOR	ITB WORK ORDER	SHEET NO 3 OF 10	REV 1	





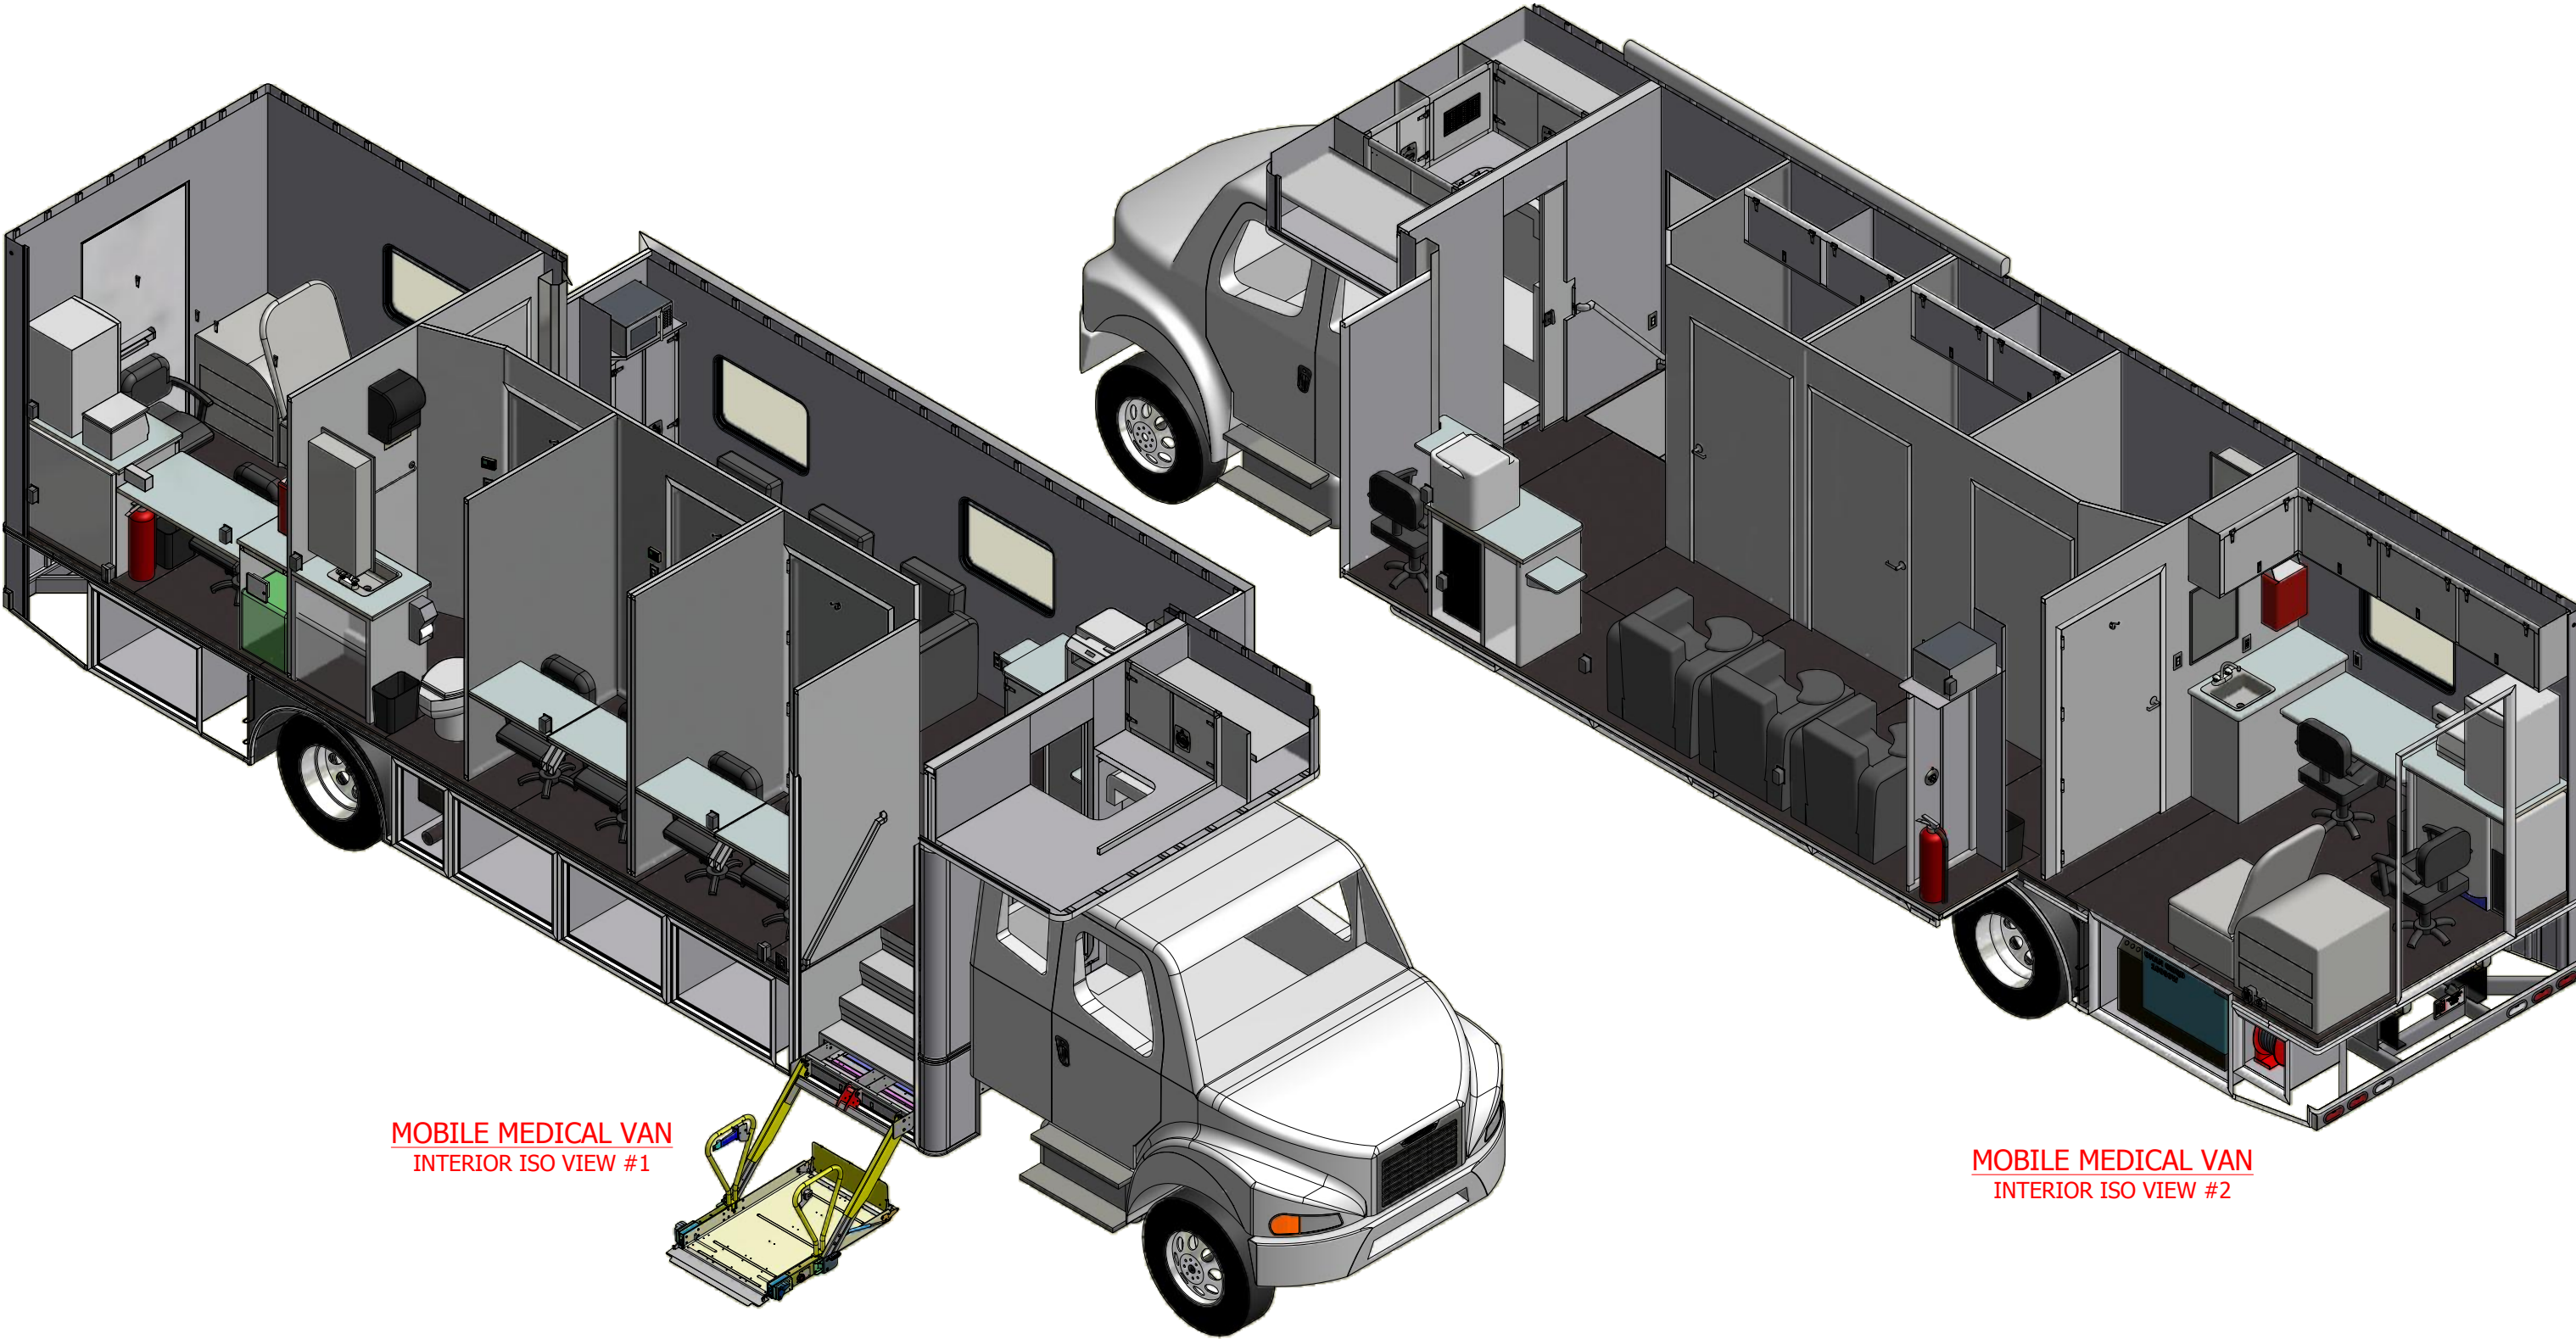


MOBILE MEDICAL VAN
INTERIOR ISO VIEW #1

MOBILE MEDICAL VAN
INTERIOR ISO VIEW #2

UNITS	SCALE	TITLE	INTERCONTINENTAL TRUCK BODY COALDALE, AB SURREY, BC 1-800-661-1030 1-888-819-2639 www.ITB.ca				
AS NOTED	AS NOTED						
DRAWN	DATE	CUSTOMER	STATION	ITB WORK ORDER	SHEET NO	REV	
MVB	2015-05-14						
CHECKED	DATE	UNIVERSITY OF ALBERTA	PRESENTATION	-	4 OF 10	1	

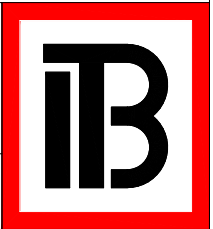


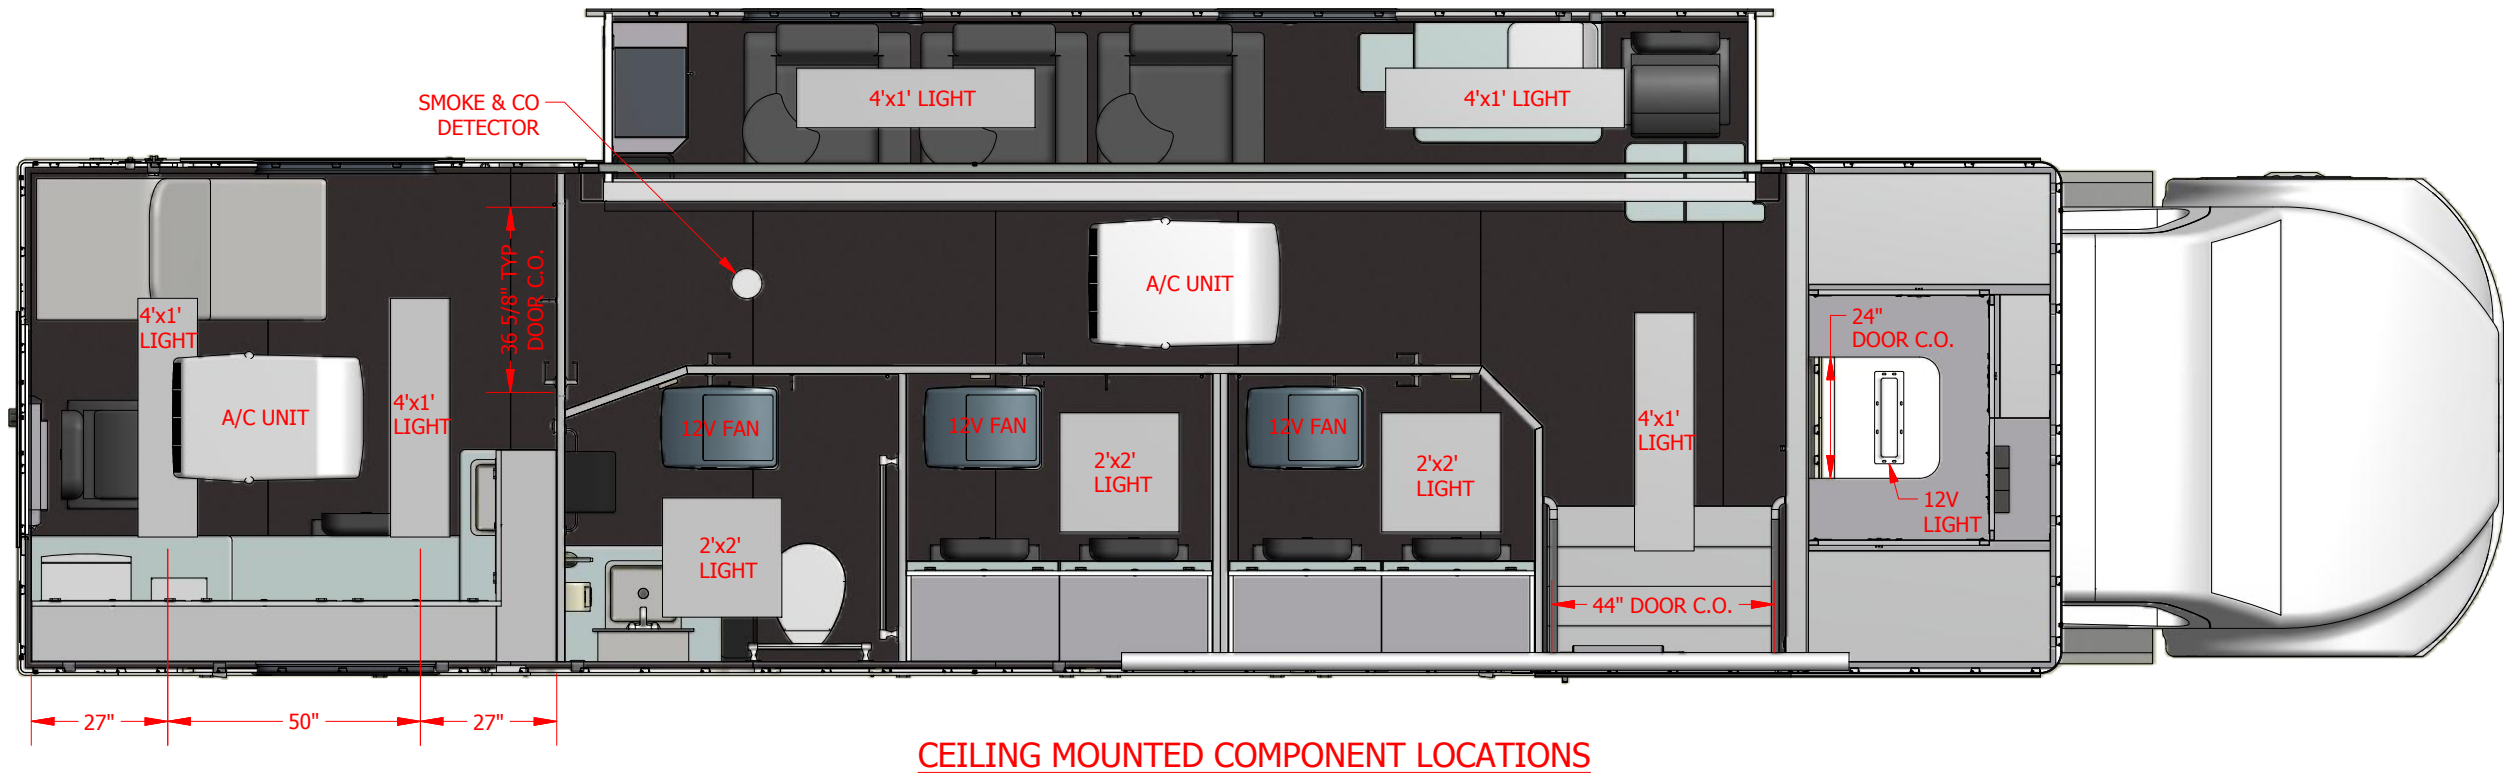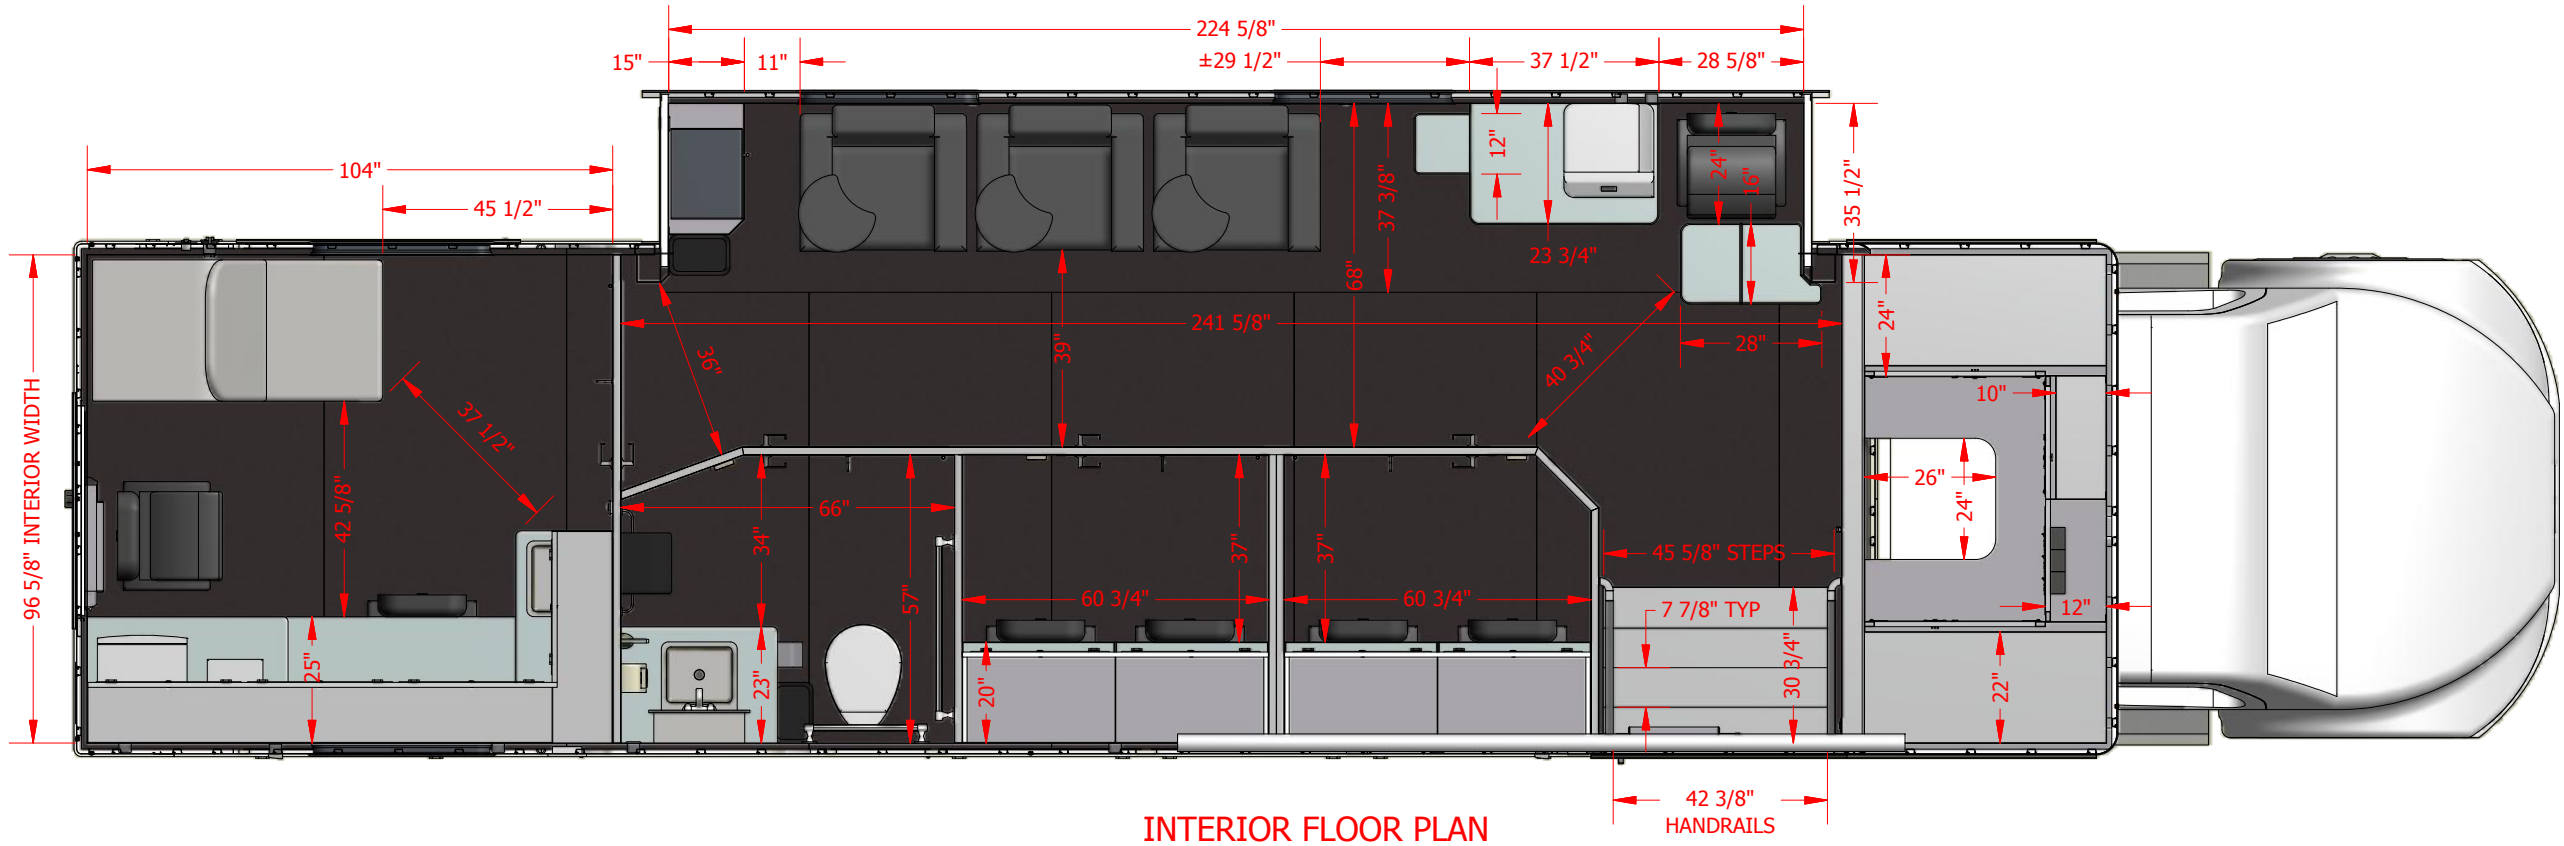


NOTES:

1. ALL DIMENSIONS ARE APPROXIMATE AND ARE DEPENDANT ON CHASSIS DIMENSIONS.
- 2.
- 3.
- 4.
- 5.

UNITS	SCALE	TITLE 29'8"L x 7'10"IDH x 8'6"W FREIGHTLINER M2-106 330" WB, (239"CA)	INTERCONTINENTAL TRUCK BODY COALDALE, AB SURREY, BC 1-800-661-1030 1-888-819-2639 www.ITB.ca			
AS NOTED	AS NOTED					
DRAWN	DATE	CUSTOMER UNIVERSITY OF ALBERTA	STATION FLOOR PLAN	ITB WORK ORDER -	SHEET NO 5 OF 10	REV 1
MVB	2015-05-14					
CHECKED	DATE					

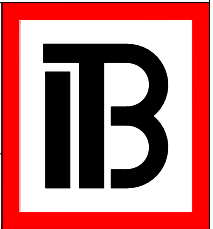

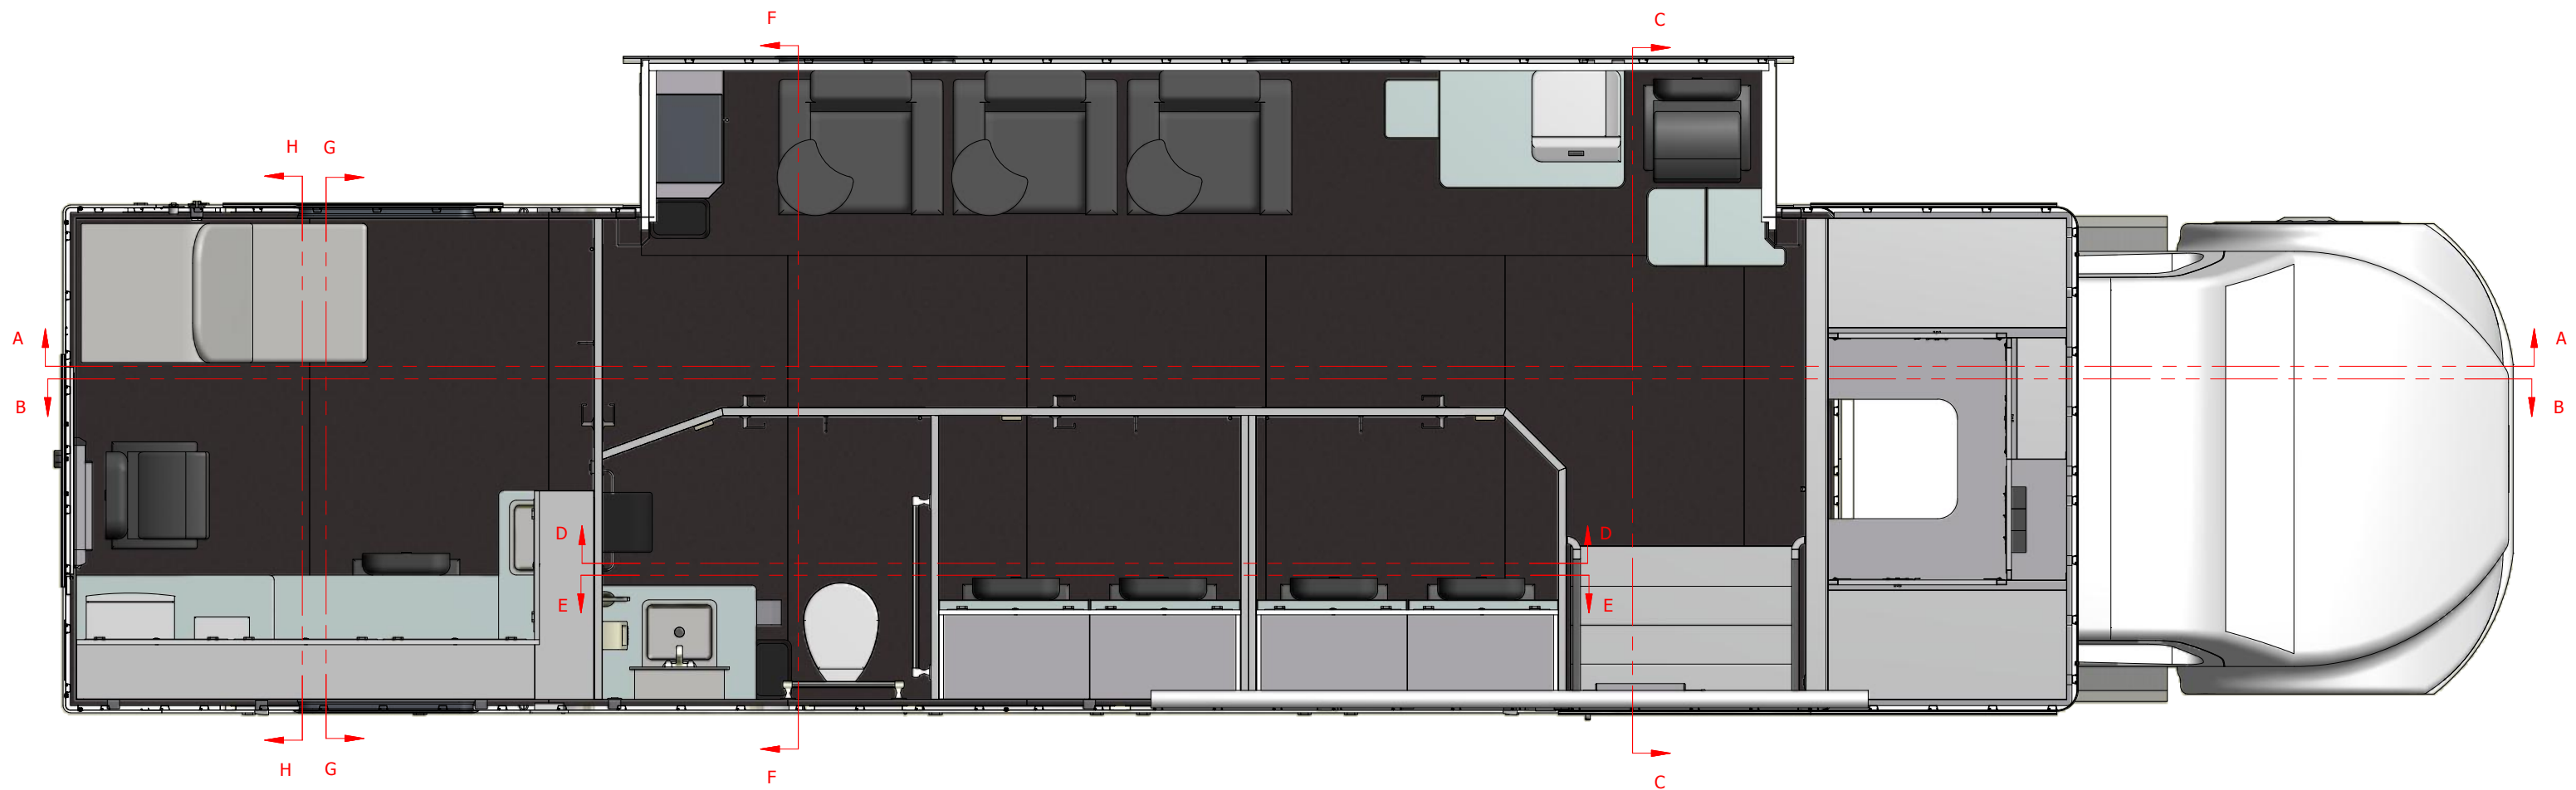



INTERIOR SECTION VIEWS - FLOOR PLAN
SEE FOLLOWING PAGES FOR INTERIOR VIEWS

NOTES:

- 1. ALL DIMENSIONS ARE APPROXIMATE AND ARE DEPENDANT ON CHASSIS DIMENSIONS.
- 2.
- 3.
- 4.
- 5.

UNITS	SCALE	TITLE	INTERCONTINENTAL TRUCK BODY			
AS NOTED	AS NOTED					
DRAWN	DATE	29'8"L x 7'10"IDH x 8'6"W FREIGHTLINER M2-106 330" WB, (239"CA)	COALDALE, AB SURREY, BC			
MVB	2015-05-14		1-800-661-1030 1-888-819-2639			
CHECKED	DATE	CUSTOMER	STATION	ITB WORK ORDER	SHEET NO	REV
		UNIVERSITY OF ALBERTA	INTERIOR	-	6 OF 10	1

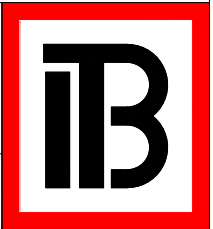


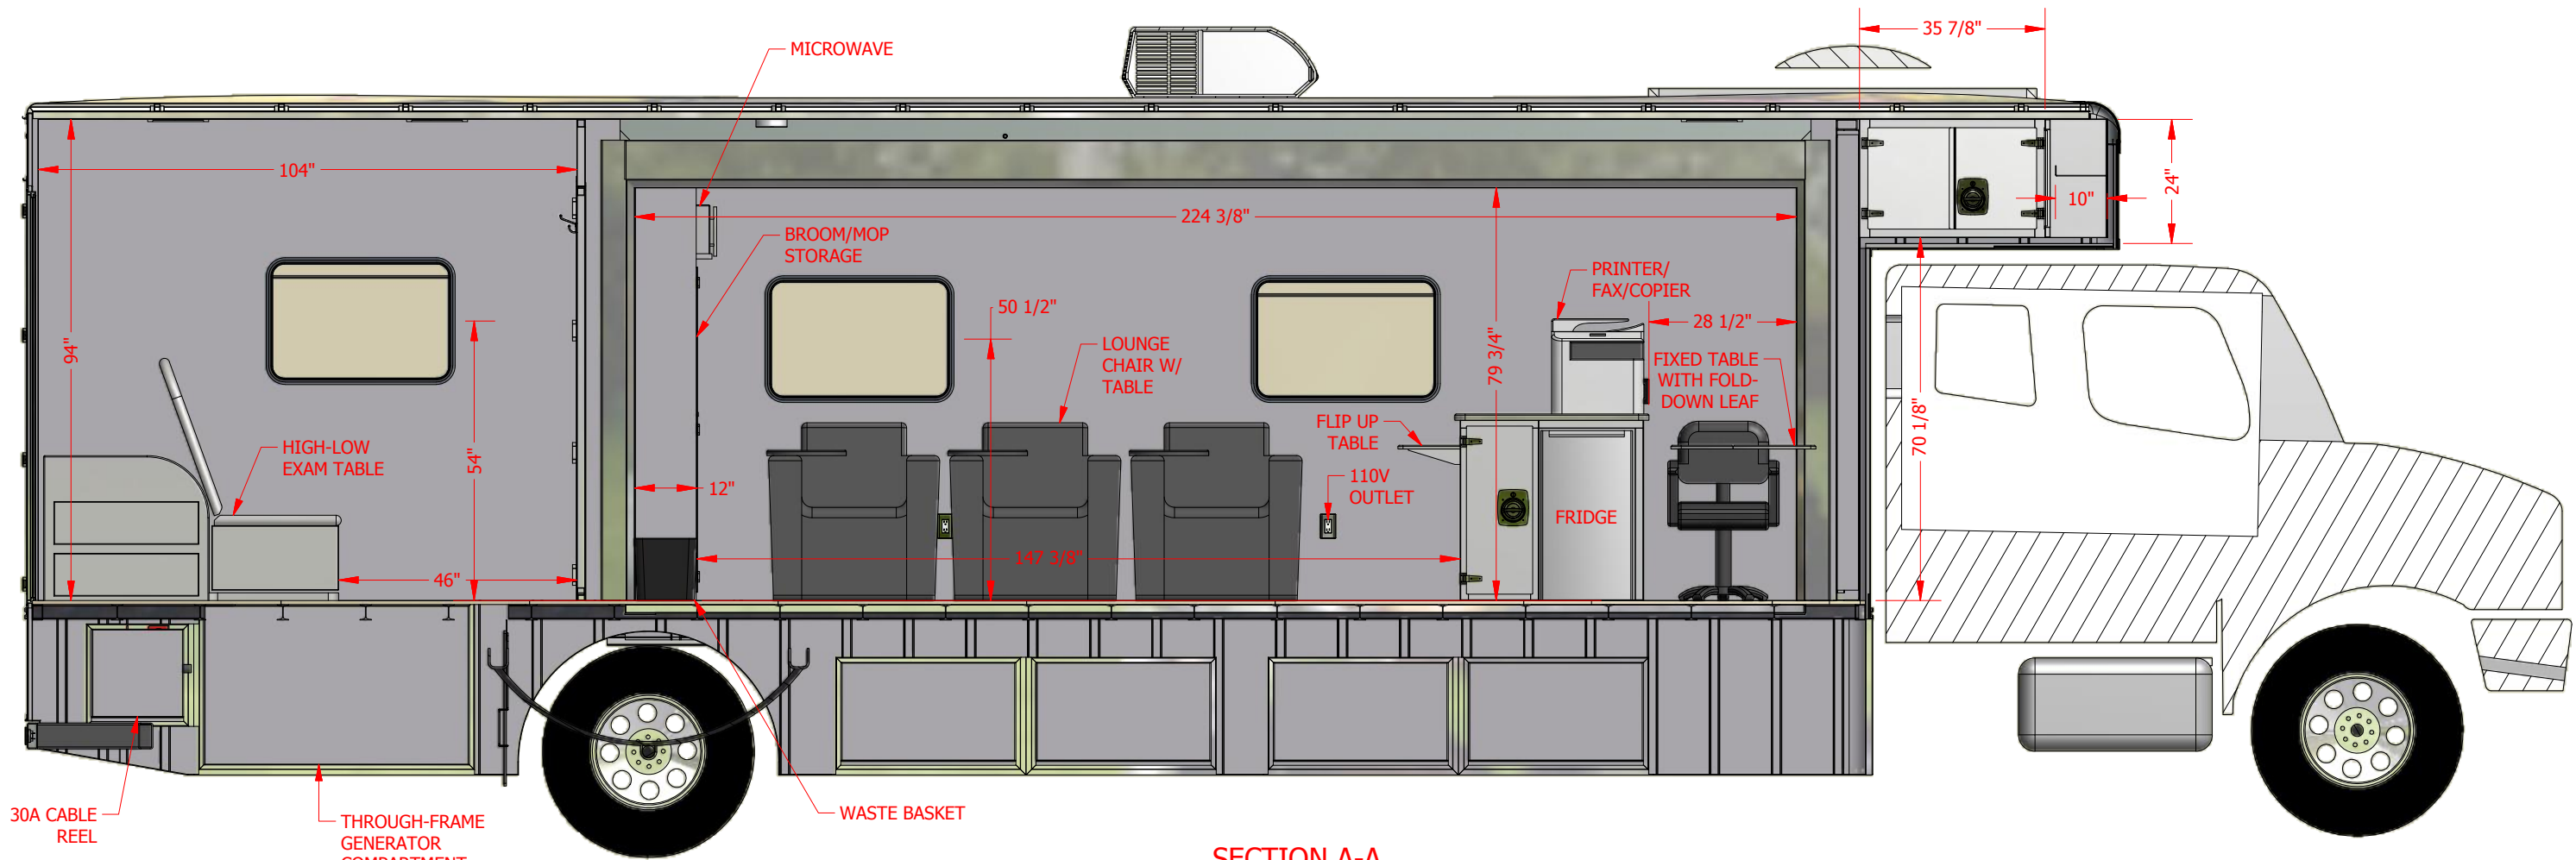


SECTION A-A
ROADSIDE INTERIOR

- NOTES:**
- 1. ALL DIMENSIONS ARE APPROXIMATE AND ARE DEPENDANT ON CHASSIS DIMENSIONS.
 - 2.
 - 3.
 - 4.
 - 5.

UNITS	SCALE	TITLE 29'8"L x 7'10"IDH x 8'6"W FREIGHTLINER M2-106 330" WB, (239"CA)	INTERCONTINENTAL TRUCK BODY COALDALE, AB SURREY, BC 1-800-661-1030 1-888-819-2639 www.ITB.ca				
DRAWN MVB	DATE 2015-05-14						
CHECKED	DATE	CUSTOMER UNIVERSITY OF ALBERTA	STATION INTERIOR	ITB WORK ORDER -	SHEET NO 7 OF 10	REV 1	

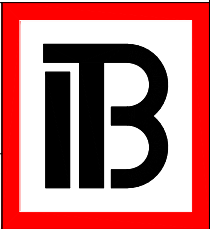

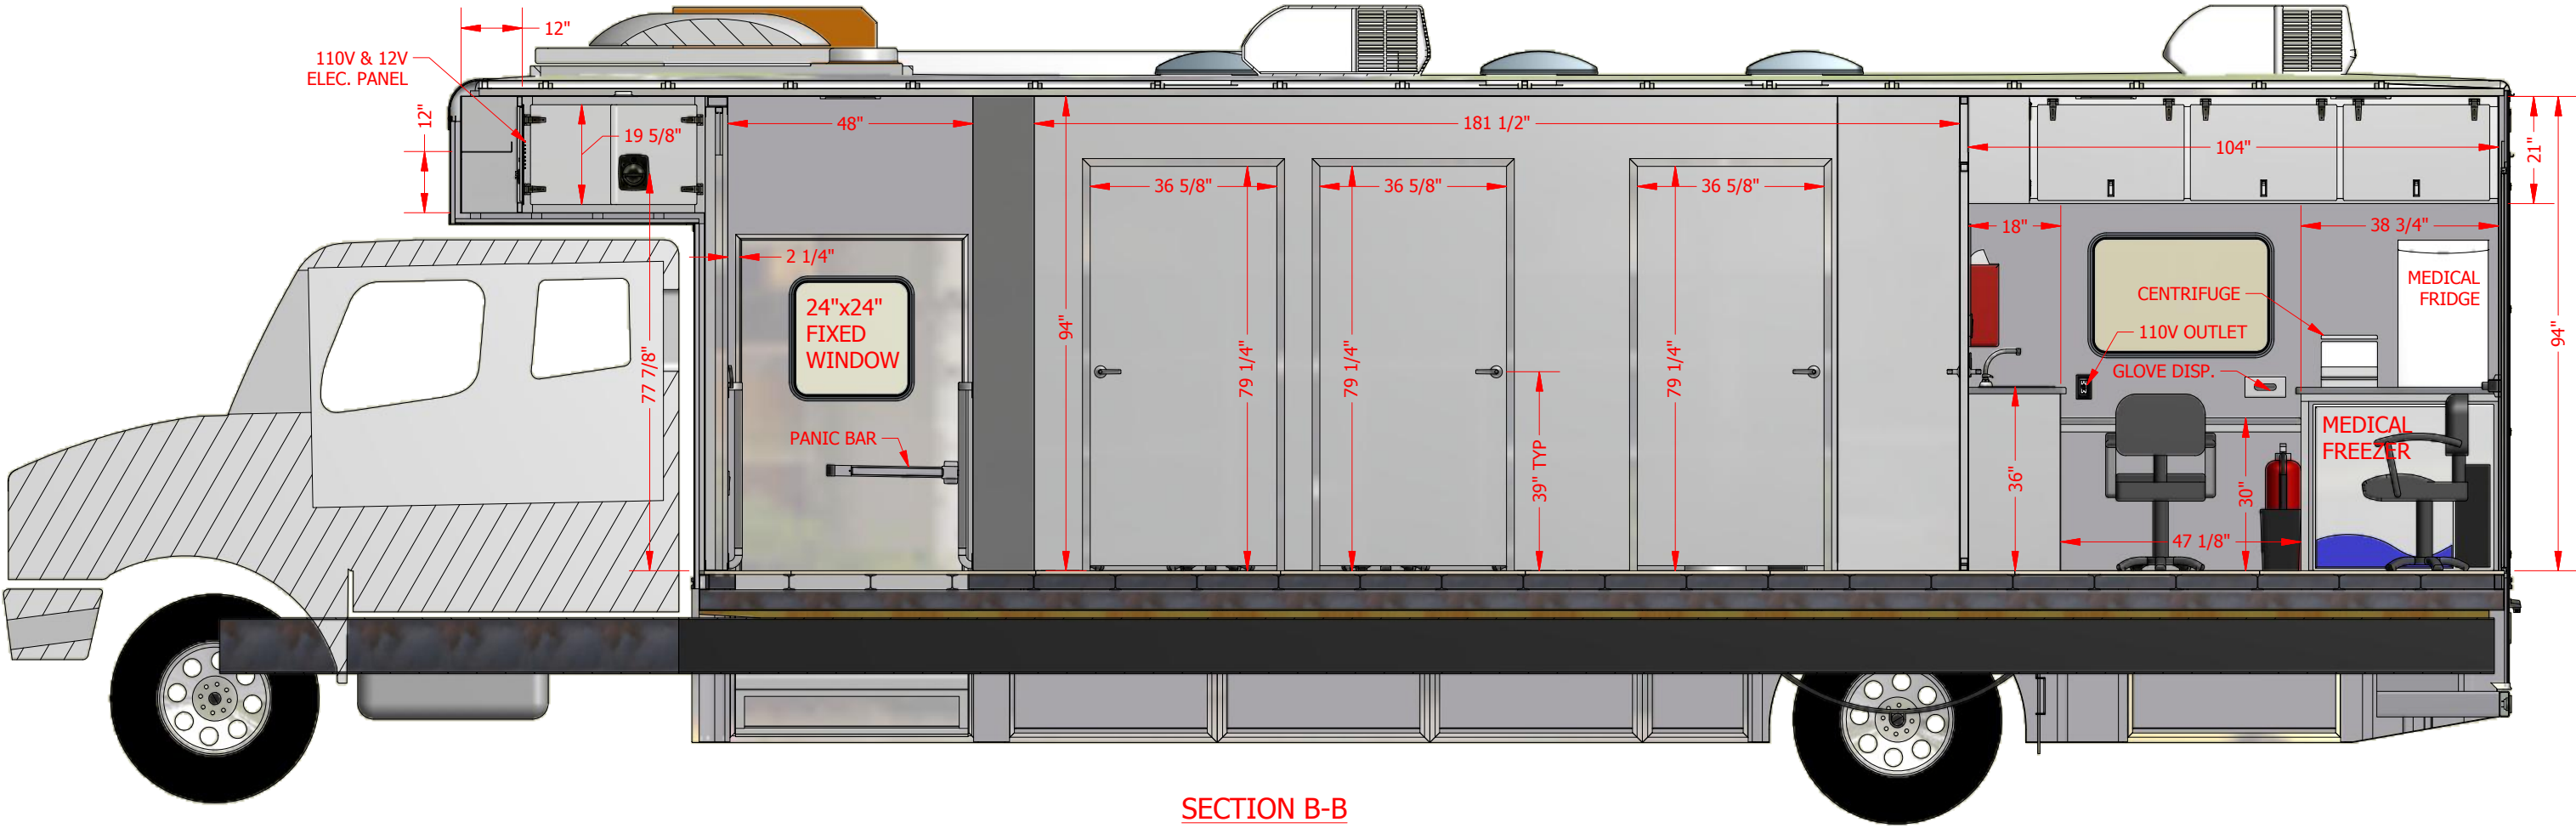



SECTION B-B
CURBSIDE INTERIOR

NOTES:


1. ALL DIMENSIONS ARE APPROXIMATE AND ARE DEPENDANT ON CHASSIS DIMENSIONS.
- 2.
- 3.
- 4.
- 5.

UNITS	SCALE	TITLE	INTERCONTINENTAL TRUCK BODY COALDALE, AB SURREY, BC 1-800-661-1030 1-888-819-2639 www.ITB.ca				
AS NOTED	AS NOTED						
DRAWN	DATE	CUSTOMER	STATION	ITB WORK ORDER	SHEET NO	REV	
MVB	2015-05-14						
CHECKED	DATE	UNIVERSITY OF ALBERTA	INTERIOR	-	8 OF 10	1	

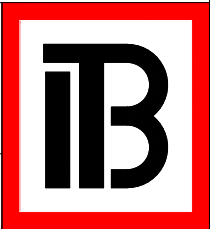


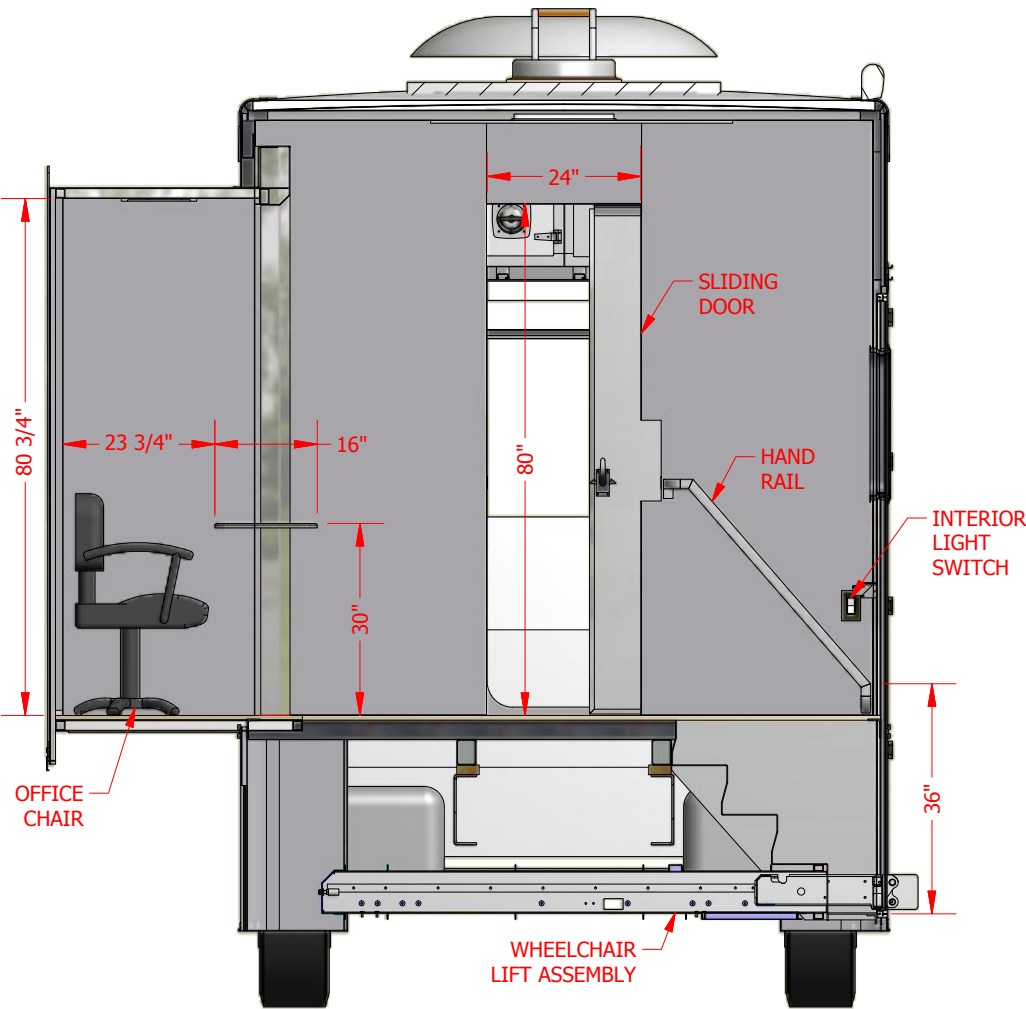

SECTION C-C
FRONT INTERIOR

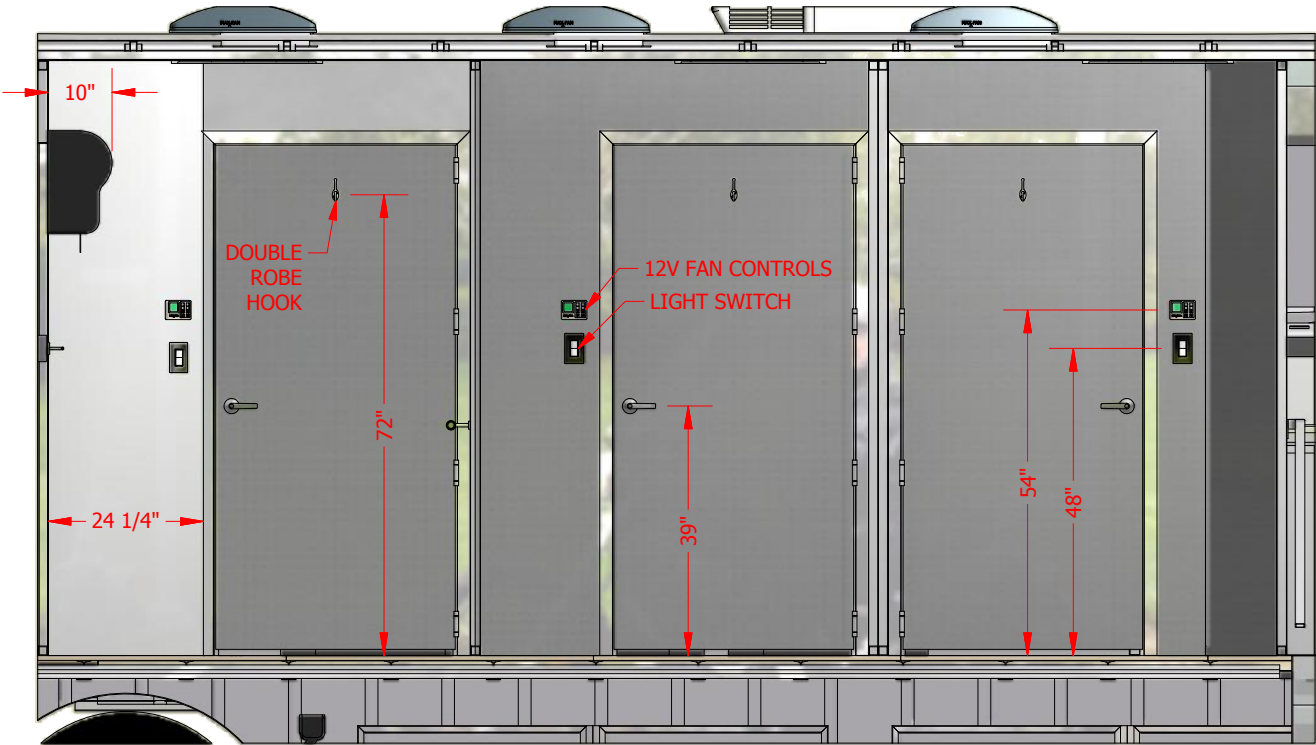

SECTION D-D
WORKROOMS/BATHROOM INTERIOR

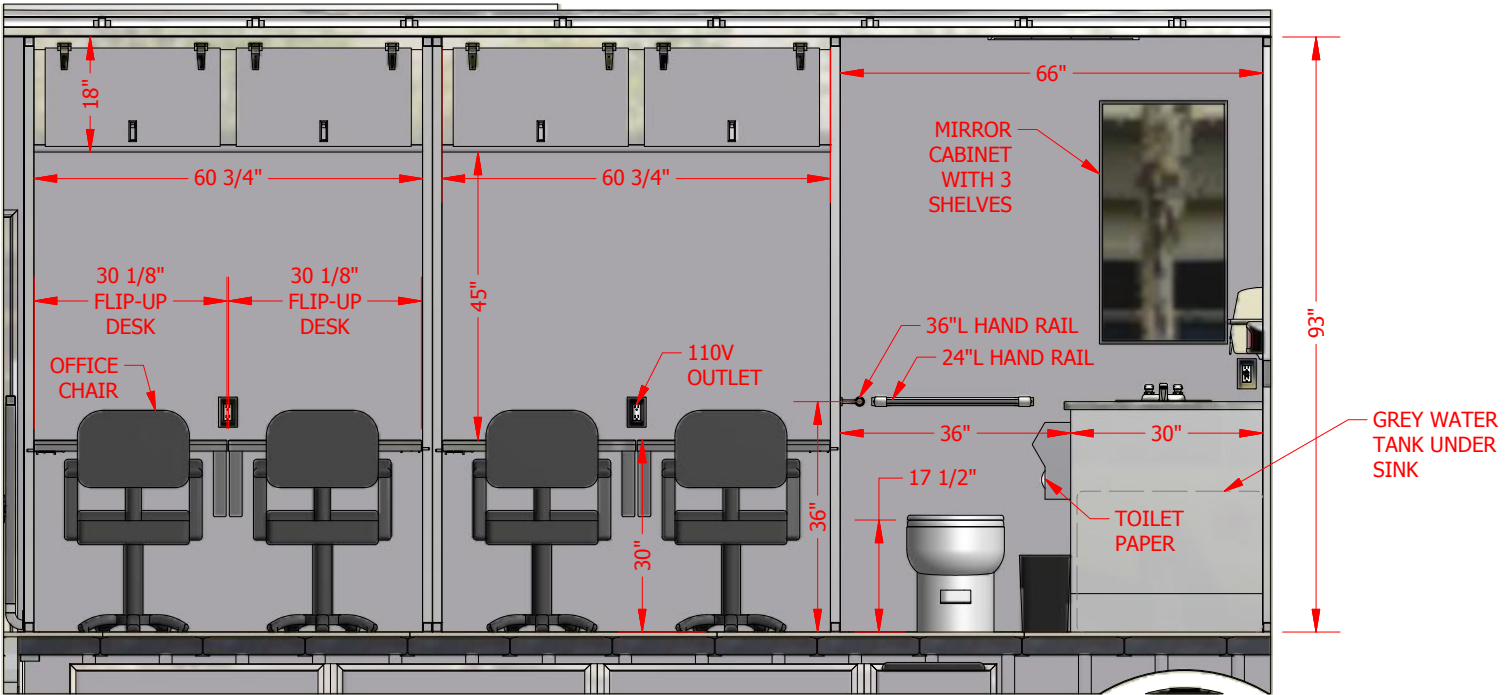



SECTION E-E
WORKROOMS/BATHROOM INTERIOR

NOTES:


1. ALL DIMENSIONS ARE APPROXIMATE AND ARE DEPENDANT ON CHASSIS DIMENSIONS.
- 2.
- 3.
- 4.
- 5.

UNITS	SCALE	TITLE	INTERCONTINENTAL TRUCK BODY COALDALE, AB SURREY, BC 1-800-661-1030 1-888-819-2639 www.ITB.ca				
AS NOTED	AS NOTED	29'8"L x 7'10"IDH x 8'6"W FREIGHTLINER M2-106 330" WB, (239"CA)					
DRAWN	DATE	CUSTOMER	STATION	ITB WORK ORDER	SHEET NO	REV	
MVB	2015-05-14	UNIVERSITY OF ALBERTA	INTERIOR	-	9 OF 10	1	
CHECKED	DATE						

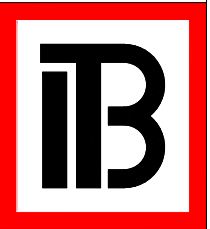


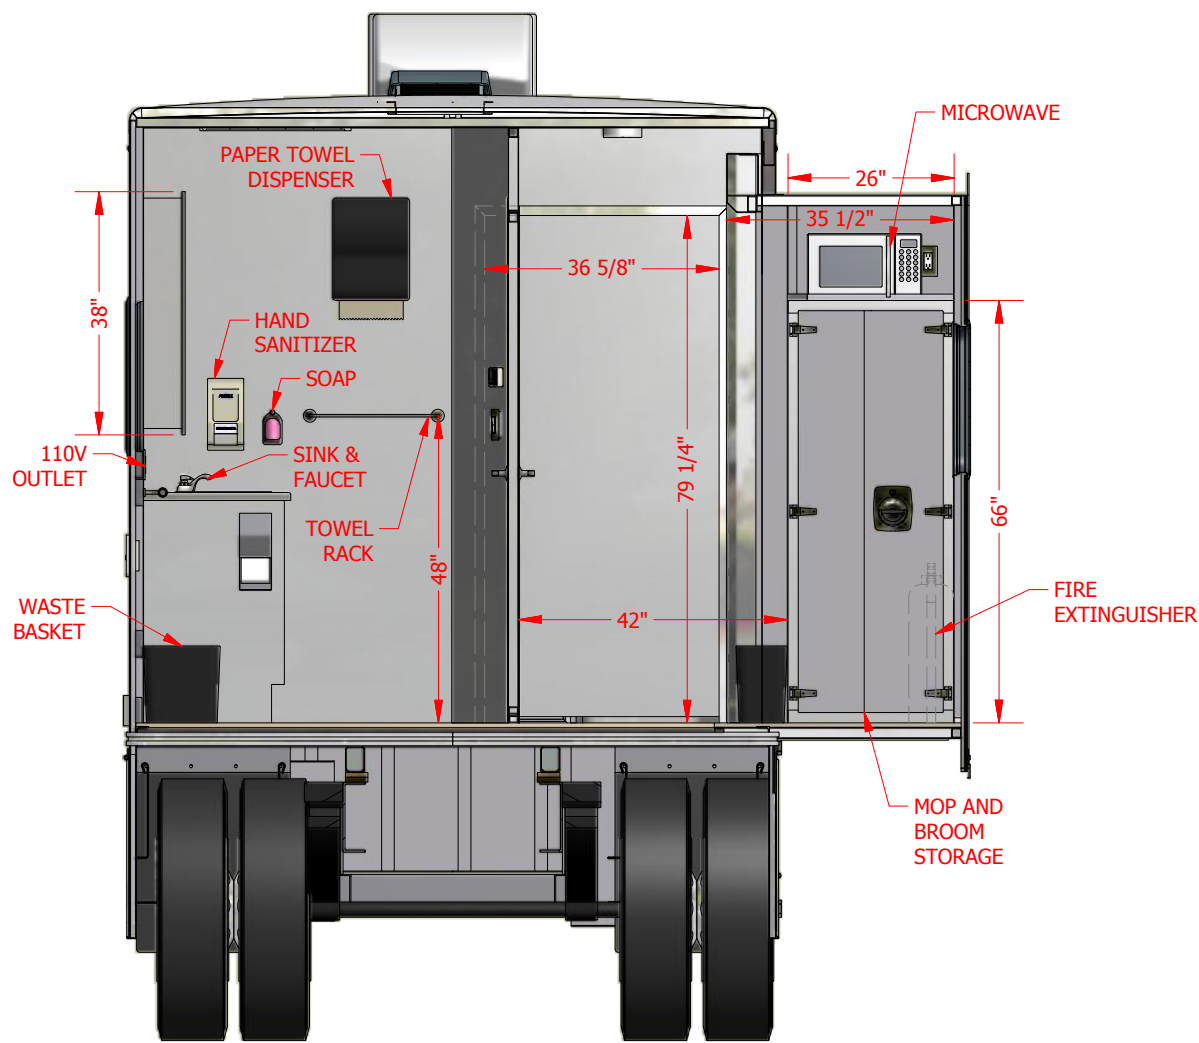

SECTION F-F
BATHROOM/WAITING AREA INTERIOR

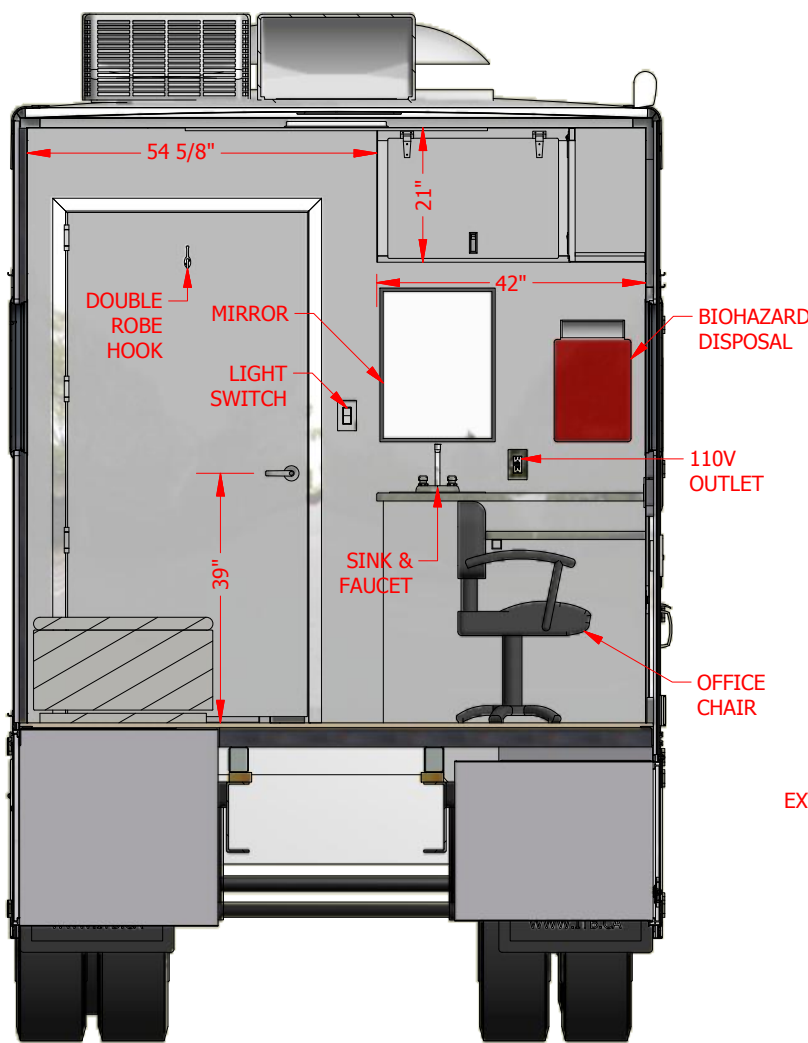

SECTION G-G
EXAMINATION ROOM INTERIOR

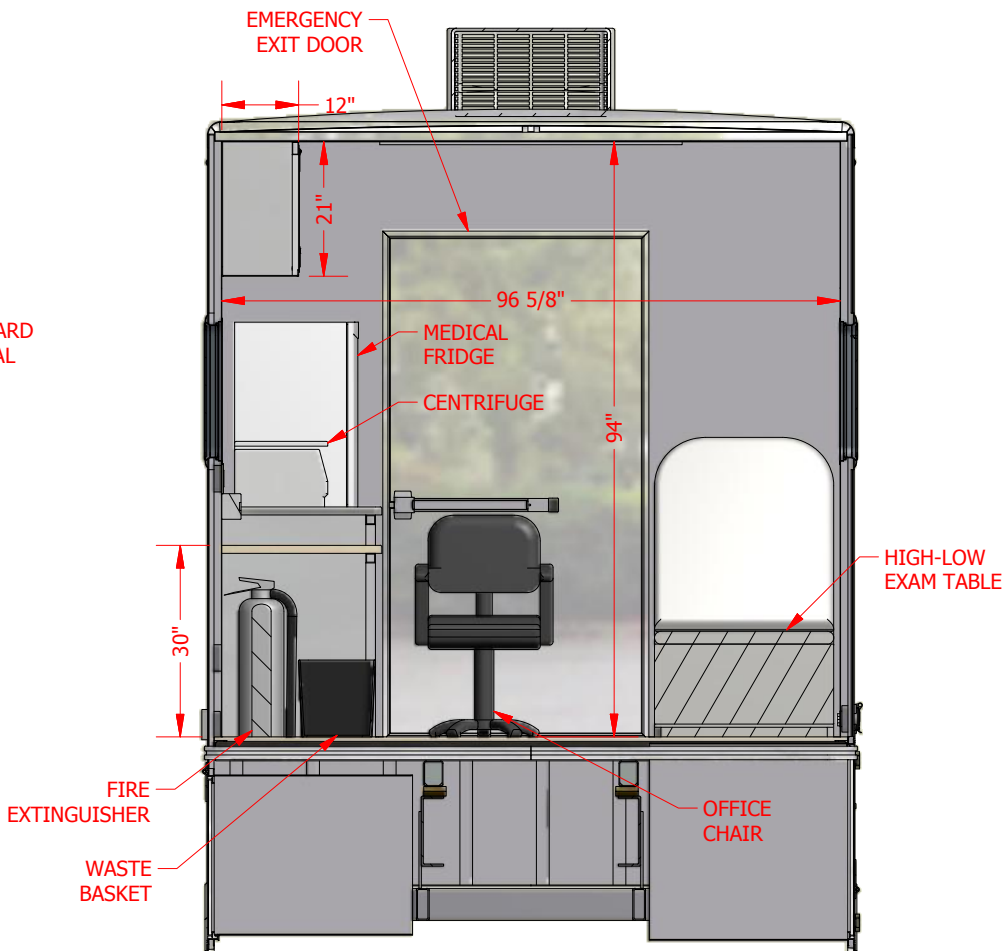



SECTION H-H
EXAMINATION ROOM INTERIOR

- NOTES:**
- 1. ALL DIMENSIONS ARE APPROXIMATE AND ARE DEPENDANT ON CHASSIS DIMENSIONS.
 - 2.
 - 3.
 - 4.
 - 5.

UNITS	SCALE	TITLE	INTERCONTINENTAL TRUCK BODY COALDALE, AB SURREY, BC 1-800-661-1030 1-888-819-2639 www.ITB.ca				
AS NOTED	AS NOTED						
DRAWN	DATE	CUSTOMER	STATION	ITB WORK ORDER	SHEET NO	REV	
MVB	2015-05-14						
CHECKED	DATE	UNIVERSITY OF ALBERTA	INTERIOR	-	10 OF 10	1	



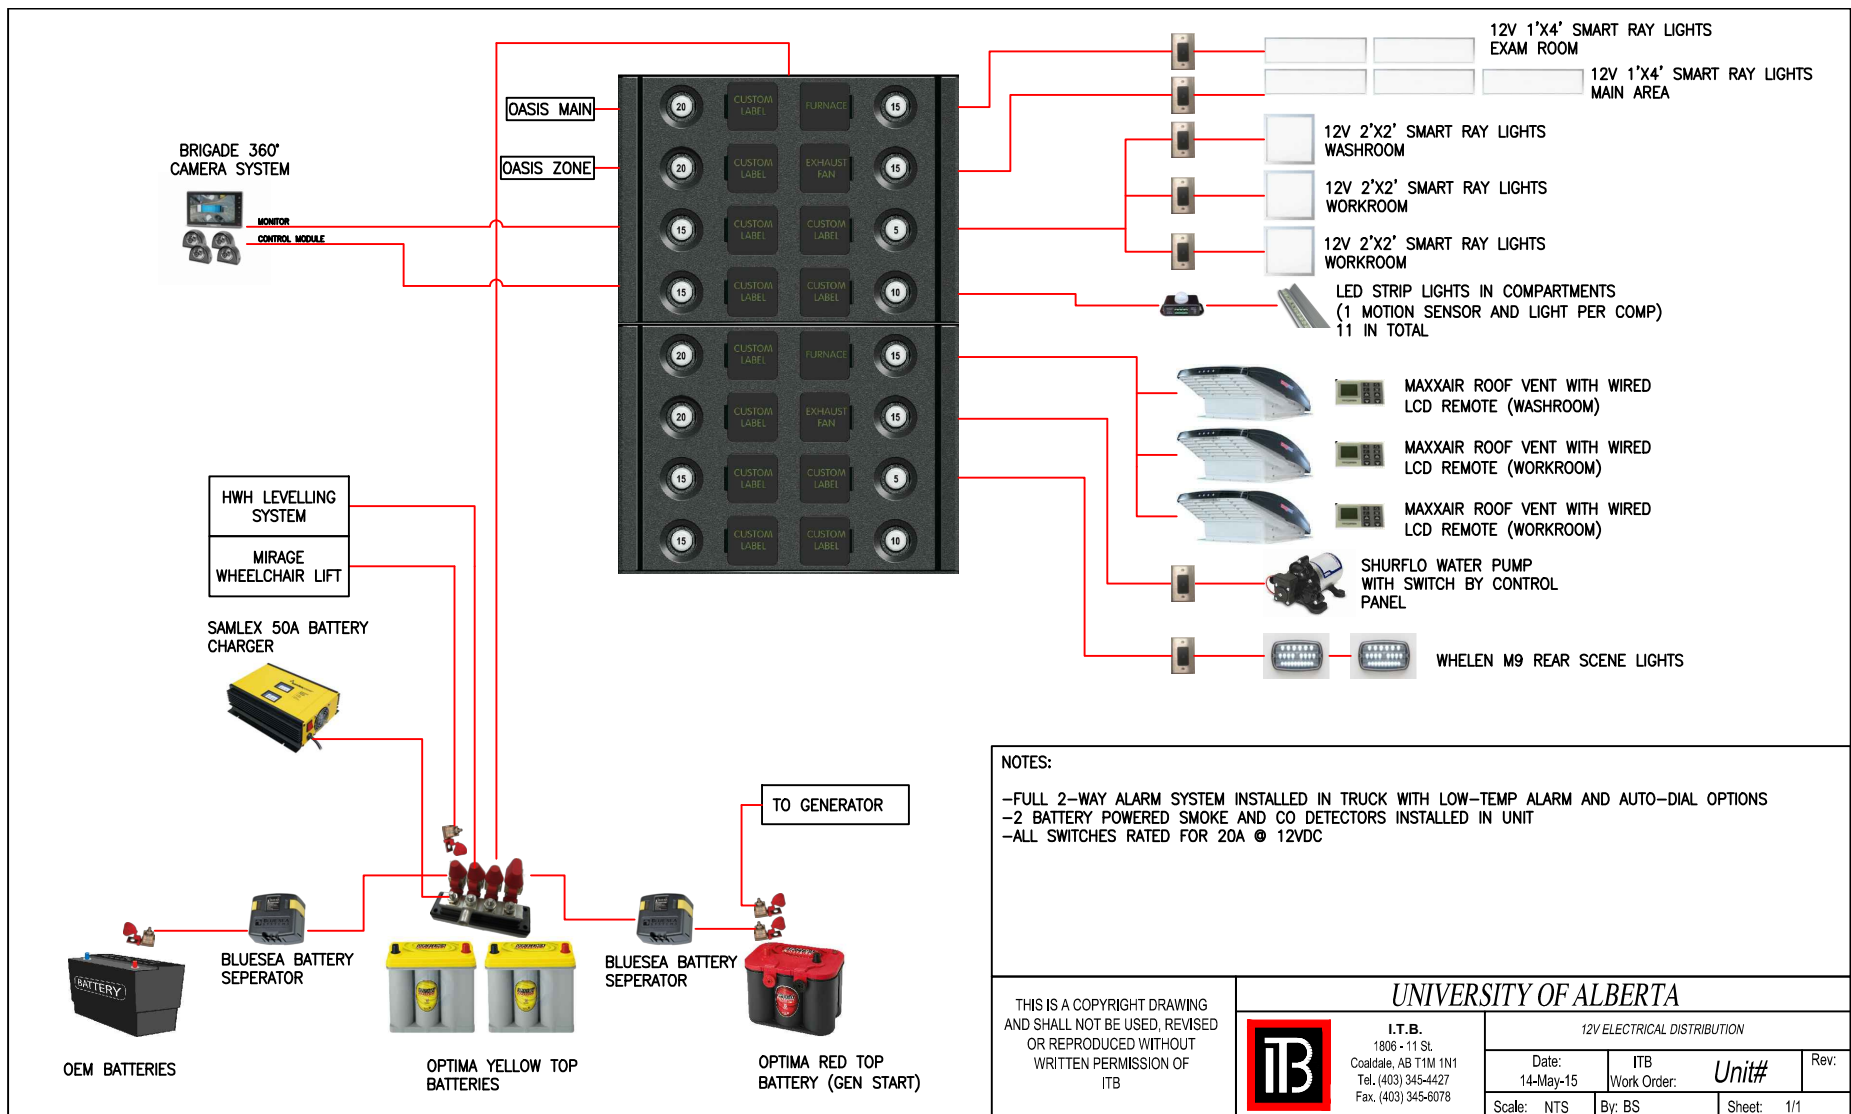

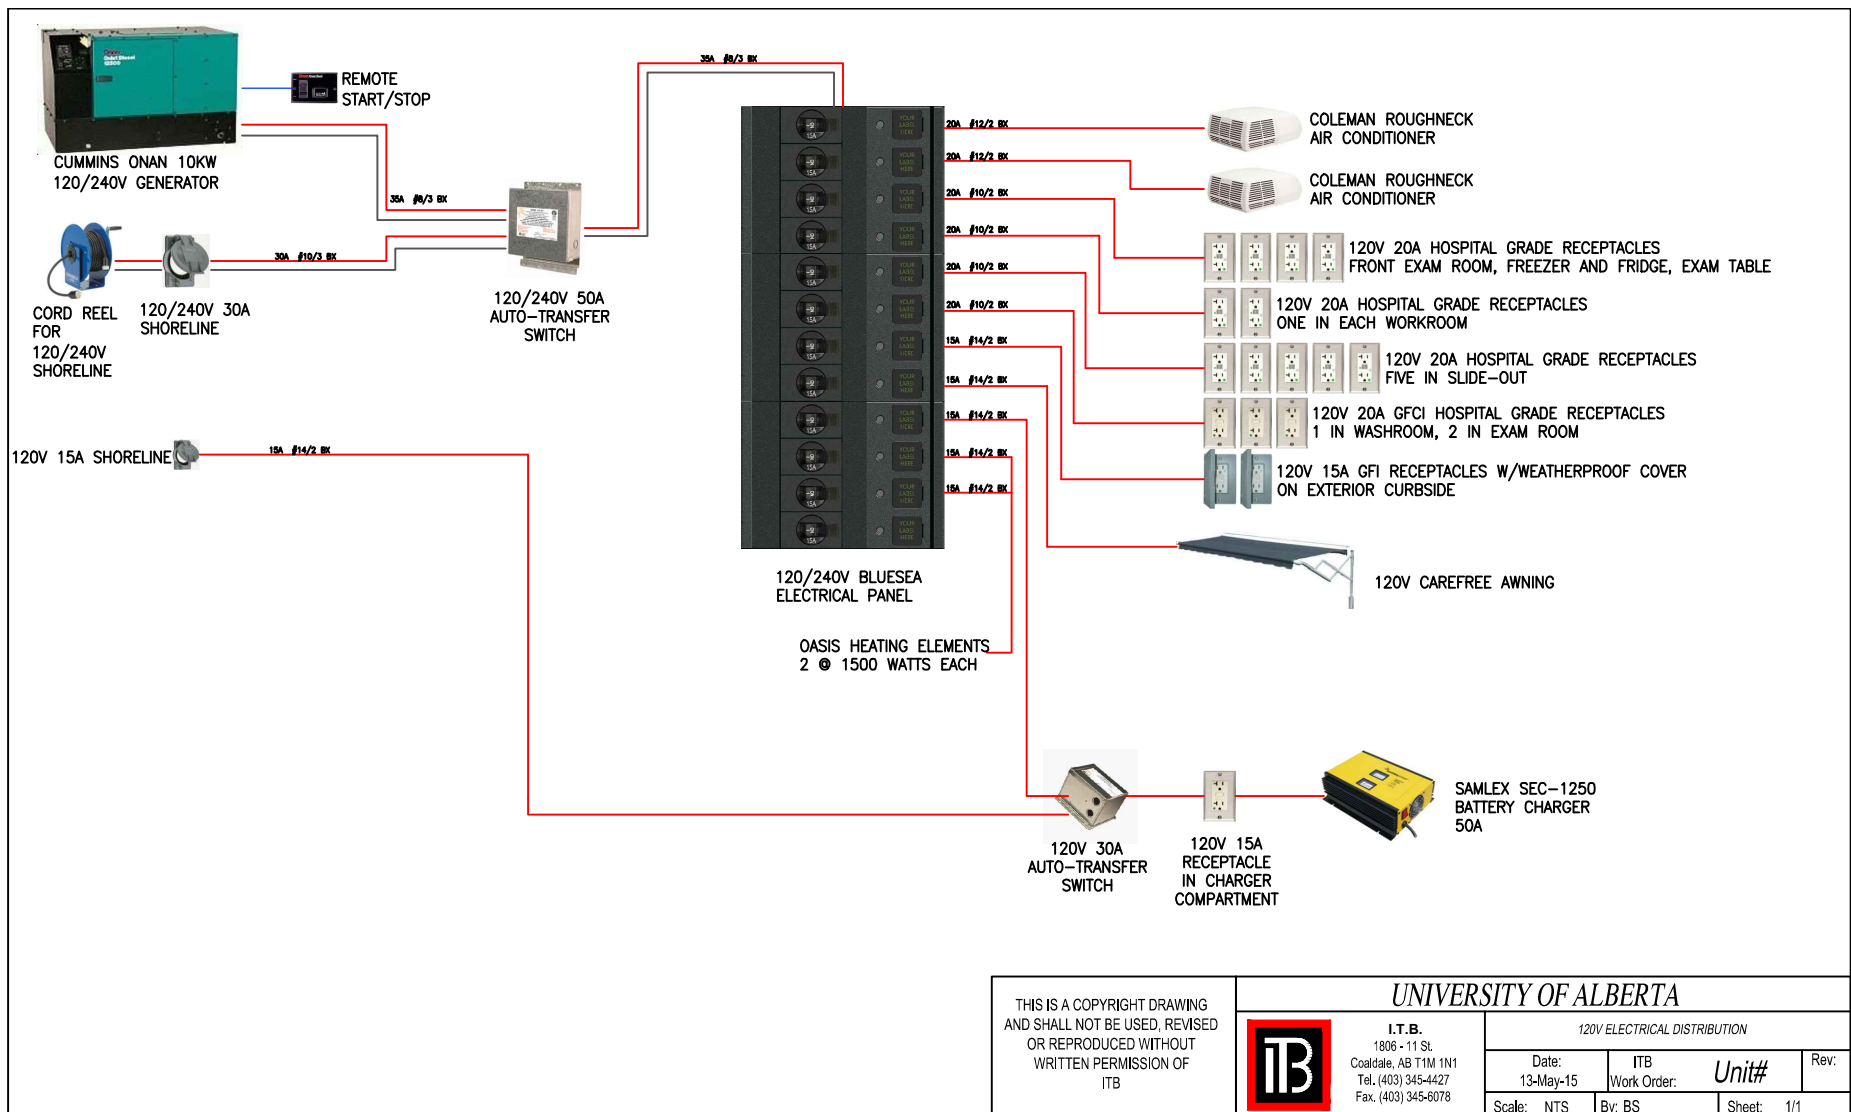

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I.T.B.
1806 - 11 St.
Coaldale, AB T1M 1N1
Tel. (403) 345-4427
Fax. (403) 345-6078

UNIVERSITY OF ALBERTA

120V ELECTRICAL DISTRIBUTION

Date: 13-May-15	ITB Work Order:	Unit#	Rev:
Scale: NTS	By: BS	Sheet:	1/1

PANEL SCHEDULE												
DESCRIPTION	VA		BREAKER		CCT #	BUSS CONN.	CCT #	BREAKER		VA		DESCRIPTION
	A	B	POLE	AMP				AMP	POLE	A	B	
GENERAL RECEPTACLE (2)	240		1	15	1	←→	2	20	1	1836		A/C UNIT #1
GENERAL RECEPTACLE (4)		1080	1	15	3	←→	4	20	1		1836	A/C UNIT #2
GENERAL RECEPTACLE (2)	240		1	15	5	←→	6	20	1	1908		BATTERY CHARGER
GENERAL RECEPTACLE (5)		1000	1	15	7	←→	8	15	1		300	AWNING
GENERAL RECEPTACLE (3)	360		1	15	9	←→	10	15	1	1500		OASIS HEATING ELEMENT
OASIS HEATING ELEMENT		1500	1	15	11	←→	12					
	840	3680								5244	2136	
TOTAL A: 6084												TOTAL B: 5816

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UNIVERSITY OF ALBERTA


PANEL SCHEDULE

Date: 13-May-15	ITB Work Order:	Unit#	Rev:
Scale: NTS	By: BS	Sheet: 1/1	

Project Name:		UNIVERSITY OF ALBERTA - MEDICAL TRUCK						
Company:		INTERCONTINENTAL TRUCK BODY						
Calculated By:		William Chao	Indoor Design temperature		20 C	68 F		
Date:		01/05/2015	Outdoor design temperature		-10 C	14 F		
Comments:		Temperature differences (ΔT)			30 C	54 F		
		Heating Degree Day			DD			
Total Insulation Values:		R' value	U' value	Enter infiltration in number of air change per hour	0.35	Numer of Air Shifts (how many times the air is replaced in the room per		0.00014
		(F.h.ft²)/BTU	BTU/h/ft²					
Walls		14.00	0.071	Heat loss thro' perimeter wall (Btu/h/ft)	23			
Roof		21.00	0.048					
Floor		21.000	0.048	Specific Heat (kJ/kg.K)	1.005			
Windows		5.000	0.200	Density of Air (kg/m3)	1.534			
Door		6.00	0.167					
Building Information								
Room Description		Main	Extension					
Width:(ft)		8.50	2.50					
Length:(ft)		39.19	19.57					
Room area: (ft²)		333.09	48.93					
Height (ft)		10.01	6.69					
Volume of room (ft³)		3334.41	327.23					
Volume of room (m3)		94.42	9.27					
Length of perimeter wall (ft)		95.38	24.57					
North Wall:		392.28						
Width (ft)		39.19	19.57					
Height (ft)		10.01	6.69					
East Wall:		85.09						
Width (ft)		8.50	2.50					
Height (ft)		10.01	6.69					
South Wall:		392.28						
Width (ft)		39.19	0.00					
Height (ft)		10.01	6.69					
West Wall:		85.09						
Width (ft)		8.50	2.50					
Height (ft)		10.01	6.69					
Roof:								
Width (ft)		8.50	2.50					
Length (ft)		39.19	19.57					
Floor:								
Width (ft)		8.50	2.50					
Length (ft)		39.19	19.57					
Window:		6.00						
Width (ft)		3.00	3.00					
Height (ft)		2.00	2.00					
Number of windows		4.00	0.00					
Door:								
Width (ft)		3.67	3.00					
Height (ft)		8.00	1.00					
Number of doors		1.00	0.00					
Gross Wall Area		954.74	164.33					
Gross window Area		24.00	0.00					
Door area (ft²)		29.33	0.00					
Net Wall area		901.41	164.33					
Gross roof area		333.09	48.93					
Gross floor area		333.09	48.93					
Heat loss thro' walls		3476.87	633.85					
Heat loss thro' windows		259.20	0.00					
Heat loss thro' roof		856.53	125.83					
Heat loss thro' door		264.00	0.00					
Heat loss thro' floor		856.53	125.83					
Heat loss thro' infiltration (W)		0.61	0.06					
Heat loss thro' infiltration (BTU/h)		2.09	0.20					
Perimeter Heat loss		2193.63	565.18					
Sub-Total Room Heat Loss (BTU/h)		7908.83	1450.88					
CFM		135.61						
Total Heat Loss (BTU/h)		9359.7						
Total Heat Loss (W)		2752.86						
50,000 BTU/h Heater		50.000	BTU/h					
		14705.88	W (J/s)					
Additional heater		1500.00	W (J/s)					
Total Heat Transfer Rate (W)		13453.02	W					
Heat Needed in the Room (From -20 to 10)			4795.49 KJ					
				30% - 50%				
Total Time required to Heat up the Empty Trailer			356.46 Seconds	534.69 Seconds				
			5.94 Minutes	8.91 Minutes				
			0.10 Hours	0.15 Hours				
If the equipments are installed inside of the trailer. more heat is required from the heater.								

All lengths in inches and weights in pounds

Printout of Load Xpert software

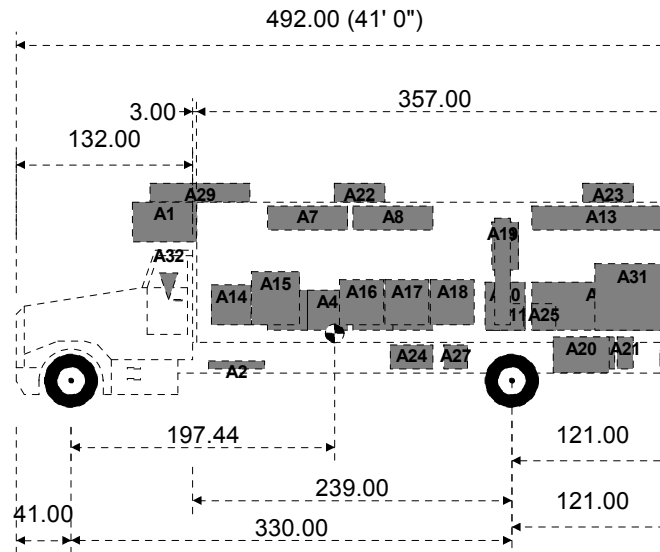


Axle Loads:

	#1 (lb)	#2 (lb)	Total (lb)
Tare:	9055	5260	14315
Body:	2154	7233	9387
Accessories:	892	5528	6420
Payload:	0	0	0
Total:	12100	18022	30122
Desired/(GVW)*:	14700	21000	(35700*)
GAWR/(GVWR)*:	14700	21000	(35700*)

Overall C.G. height from ground (in): 55.65

ESTIMATED WEIGHT CALCULATION FOR THE PROPOSED MOBILE MEDICAL UNIT FOR UNIVERSITY OF ALBERTA.

Title: MOBILE MEDICAL UNIT	Company: UNIVERSITY OF ALBERTA	Date: MAY 14, 2015
	Ref.:	By: MVB

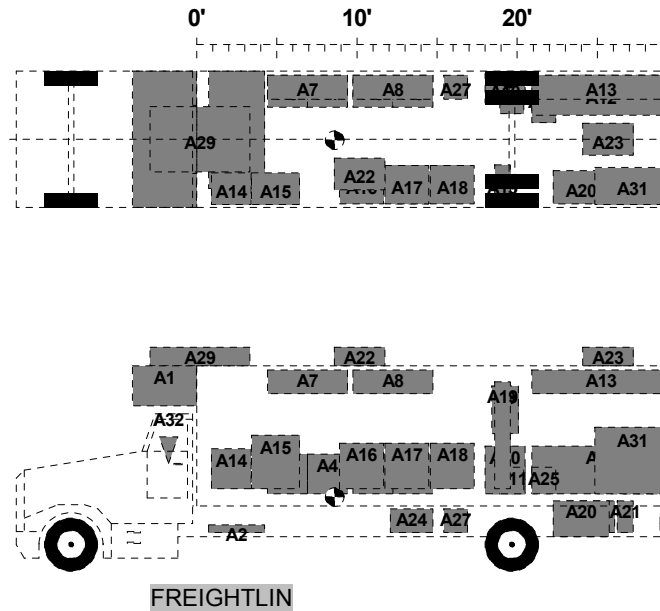**Axle Loads:**

	#1 (lb)	#2 (lb)	Total (lb)
Tare:	9055	5260	14315
Body:	2154	7233	9387
Accessories:	892	5528	6420
Payload:	0	0	0
Total:	12100	18022	30122
Desired/(GVW)*:	14700	21000	(35700*)
GAWR/(GVWR)*:	14700	21000	(35700*)

⊙ = Overall center of gravity

ESTIMATED WEIGHT CALCULATION FOR THE PROPOSED MOBILE MEDICAL UNIT FOR UNIVERSITY OF ALBERTA.

Title: MOBILE MEDICAL UNIT	Company: UNIVERSITY OF ALBERTA	Date: MAY 14, 2015
	Ref.:	By: MVB


Maximum Payload

Based on lesser of the Desired Loads and Weight Ratings

Desired GVW: 35700 (lb)

↓ = Maximum Payload		Unit 1 (Truck)
Weight:	(lb)	5577
C.G. Position * :	(in)	82.20

* measured for chassis from back of cab, for other Units from front end of Body.

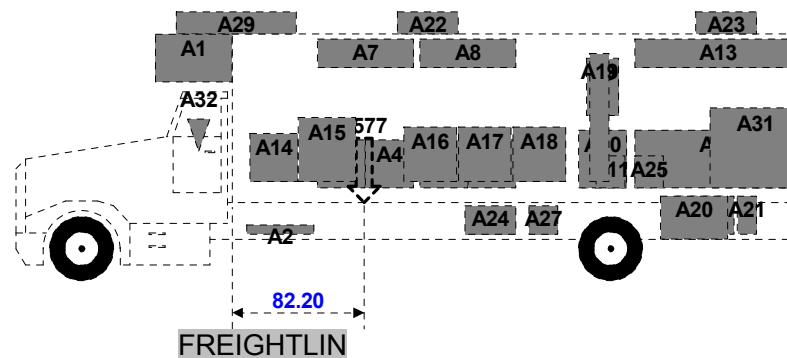

Axle Loads:	#1 (lb)	#2 (lb)	Total (lb)
Tare:	9055	5260	14315
Body:	2154	7233	9387
Accessories:	892	5528	6420
Payload:	2599	2978	5577
Total:	14699	21000	35699
Desired/(GVW)*:	14700	21000	(35700*)
GAWR/(GVWR)*:	14700	21000	(35700*)

ESTIMATED WEIGHT CALCULATION FOR THE PROPOSED MOBILE MEDICAL UNIT FOR UNIVERSITY OF ALBERTA.

Title: MOBILE MEDICAL UNIT	Company: UNIVERSITY OF ALBERTA	Date: MAY 14, 2015
	Ref.:	By: MVB

ACCESSORY DESCRIPTION TABLE for MOBILE MEDICAL UNIT

Printout of Load Xpert software

Company: UNIVERSITY OF ALBERTA

Unit 1: FREIGHTLINER M2-106 33

Ref.:

Date: MAY 14, 2015

Unit #	ID	Accessory Name	Weight (lb)	Length (in)	Width (in)	Height (in)	Pos-X (in)	Pos-Y (in)	Pos-Z (in)	CG-X (in)	CG-Y (in)	CG-Z (in)
1	A1	KICKOVER CABINETS + PANEL	220	48.00	102.00	30.00	-45.00	0.00	75.00	24.00	51.00	15.00
1	A2	WHEELCHAIR LIFT	700	42.00	88.00	6.00	12.00	7.00	-20.00	21.00	44.00	3.00
1	A3	DESK WITH CHAIR	80	30.00	24.00	30.00	56.00	36.00	9.00	15.00	12.00	15.00
1	A4	DESK WITH CHAIR	80	30.00	24.00	30.00	86.00	36.00	9.00	15.00	12.00	15.00
1	A5	DESK WITH CHAIR	80	30.00	24.00	30.00	120.00	36.00	9.00	15.00	12.00	15.00
1	A6	DESK WITH CHAIR	80	30.00	24.00	30.00	150.00	36.00	9.00	15.00	12.00	15.00
1	A7	OVERHEAD CABINET - WORK ROOM	40	60.00	18.00	18.00	56.00	39.00	84.00	30.00	9.00	9.00
1	A8	OVERHEAD CABINET - WORK ROOM	40	60.00	18.00	18.00	120.00	39.00	84.00	30.00	9.00	9.00
1	A9	MIRROR CABINET - WASHROOM	50	20.00	8.00	36.00	224.00	45.00	54.00	10.00	4.00	18.00
1	A10	SINK WITH CABINET - WASHROOM	80	30.00	22.00	36.00	219.00	38.00	9.00	15.00	11.00	18.00
1	A11	TOILET WITH FRAMEWORK	120	18.00	30.00	20.00	230.00	34.00	9.00	9.00	15.00	10.00
1	A12	L-SHAPED DESK WITH FRIDGE & CUPBOARD	250	104.00	30.00	36.00	254.00	33.00	9.00	52.00	15.00	18.00
1	A13	OVERHEAD CABINET - EXAM ROOM	80	104.00	18.00	18.00	254.00	39.00	84.00	52.00	9.00	9.00
1	A14	DESK WITH CHAIR	80	30.00	24.00	30.00	14.00	-37.00	13.00	15.00	12.00	15.00
1	A15	CABINET WITH FRIDGE & PRINTER	210	36.00	24.00	40.00	44.00	-37.00	13.00	18.00	12.00	20.00
1	A16	ARM CHAIR - SLIDE-OUT	65	33.00	29.00	34.00	110.00	-34.00	13.00	16.50	14.50	17.00
1	A17	ARM CHAIR - SLIDE-OUT	65	33.00	29.00	34.00	144.00	-34.00	13.00	16.50	14.50	17.00

Pos-X: Measured for trucks and tractors from back of cab to front of Accessory. For other Units, from front of Body to front of Accessory.

Pos-Y: Measured from centerline of Vehicle to centerline of Accessory. (negative towards left side)

Pos-Z: Measured for trucks and tractors from top of chassis frame to bottom of Accessory. For other Units, from bed floor to bottom of Accessory.

CG-X: Horizontal distance between front of Accessory and its center of gravity.

CG-Y: Lateral distance between left side (driver's side) of Accessory and its center of gravity.

CG-Z: Vertical distance between bottom of Accessory and its center of gravity.

ACCESSORY DESCRIPTION TABLE for MOBILE MEDICAL UNIT

Printout of Load Xpert software

Company: UNIVERSITY OF ALBERTA

Unit 1: FREIGHTLINER M2-106 33

Ref.:

Date: MAY 14, 2015

Unit #	ID	Accessory Name	Weight (lb)	Length (in)	Width (in)	Height (in)	Pos-X (in)	Pos-Y (in)	Pos-Z (in)	CG-X (in)	CG-Y (in)	CG-Z (in)
1	A18	`ARM CHAIR - SLIDE-OUT	65	33.00	29.00	34.00	178.00	-34.00	13.00	16.50	14.50	17.00
1	A19	`BROOM CABINET WITH MICROWA	115	12.00	30.00	80.00	226.00	-34.00	13.00	6.00	15.00	40.00
1	A20	`GENERATOR - ONAN QD 10000	850	42.00	25.00	27.00	270.00	-36.00	-23.00	21.00	12.50	13.50
1	A21	`CABLE REEL W/ CABLE	80	12.00	24.00	24.00	318.00	-37.00	-20.00	6.00	12.00	12.00
1	A22	`AIR CONDITIONER - COLEMAN RO	80	38.00	24.00	14.00	106.00	-26.00	105.00	19.00	12.00	7.00
1	A23	`AIR CONDITIONER - COLEMAN RO	80	38.00	24.00	14.00	292.00	0.00	105.00	19.00	12.00	7.00
1	A24	`BATTERY COMPARTMENT	250	32.00	25.00	18.00	148.00	-36.00	-20.00	16.00	12.50	9.00
1	A25	`WATER TANK - FRESH (FULL)	490	18.00	35.00	20.00	254.00	30.00	9.00	9.00	17.50	10.00
1	A26	`WATER TANK - GREY (FULL)	490	29.00	19.00	22.00	220.00	39.00	9.00	14.50	9.50	11.00
1	A27	`WATER TANK - BLACK (FULL)	215	18.00	18.00	18.00	188.00	39.00	-20.00	9.00	9.00	9.00
1	A28	`OASIS HEATER	200	36.00	24.00	24.00	280.00	36.00	-20.00	18.00	12.00	12.00
1	A29	`SATELLITE - MOBOSAT KU 1.2	185	75.00	49.00	14.00	-32.00	0.00	105.00	37.50	24.50	7.00
1	A30	`FREEZER - ULTRA-LOW TEMP	250	35.50	22.00	32.00	322.00	37.00	9.00	17.75	11.00	16.00
1	A31	`MEDICAL EXAM TABLE	500	57.00	28.00	50.00	301.00	-35.00	9.00	28.50	14.00	25.00
1	A32	`3RD PASSENGER	250	0.00	0.00	0.00	-18.00	0.00	32.00	0.00	0.00	0.00

Pos-X: Measured for trucks and tractors from back of cab to front of Accessory. For other Units, from front of Body to front of Accessory.

Pos-Y: Measured from centerline of Vehicle to centerline of Accessory. (negative towards left side)

Pos-Z: Measured for trucks and tractors from top of chassis frame to bottom of Accessory. For other Units, from bed floor to bottom of Accessory.

CG-X: Horizontal distance between front of Accessory and its center of gravity.

CG-Y: Lateral distance between left side (driver's side) of Accessory and its center of gravity.

CG-Z: Vertical distance between bottom of Accessory and its center of gravity.

Payload Analysis for MOBILE MEDICAL UNIT

Based on Weight Ratings

Printout of Load Xpert software

Company:	UNIVERSITY OF ALBERTA	Unit:	FREIGHTLINER M2-106 330WB/239CA SRA (Truck)
Ref.:		Make:	FREIGHTLINER
Date:	MAY 14, 2015	Model #:	M2-106
		Year:	2016
		VIN #:	

Allowable Payload: 5578 (lb)
(Based on Weight Ratings)
(Allowable payload = lowest of GVWR and sum(GAWR) - Total weight)

Total Weight	(summation of weights in table below):	30122 (lb)
GVWR	(Gross Vehicle Weight Rating):	35700 (lb)
sum(GAWR)	(summation of axle ratings):	35700 (lb)

Item description	Weight (lb)
Truck: Tare weight (includes all axles)	14315
Body weight	9387
Accessories: A1: `KICKOVER CABINETS + PANEL	220
A2: `WHEELCHAIR LIFT	700
A3: `DESK WITH CHAIR	80
A4: `DESK WITH CHAIR	80
A5: `DESK WITH CHAIR	80
A6: `DESK WITH CHAIR	80
A7: `OVERHEAD CABINET - WORK ROOM	40
A8: `OVERHEAD CABINET - WORK ROOM	40
A9: `MIRROR CABINET - WASHROOM	50
A10: `SINK WITH CABINET - WASHROOM	80
A11: `TOILET WITH FRAMEWORK	120
A12: `L-SHAPED DESK WITH FRIDGE & CHAIR - EXAM ROOM	250
A13: `OVERHEAD CABINET - EXAM ROOM	80
A14: `DESK WITH CHAIR	80
A15: `CABINET WITH FRIDGE & PRINTER	210
A16: `ARM CHAIR - SLIDE-OUT	65
A17: `ARM CHAIR - SLIDE-OUT	65
A18: `ARM CHAIR - SLIDE-OUT	65
A19: `BROOM CABINET WITH MICROWAVE - SLIDEOUT	115
A20: `GENERATOR - ONAN QD 10000	850
A21: `CABLE REEL W/ CABLE	80

Based on Weight Ratings

Printout of Load Xpert software

Total Weight	(summation of weights in table below):	30122 (lb)
GVWR	(Gross Vehicle Weight Rating):	35700 (lb)
sum(GAWR)	(summation of axle ratings):	35700 (lb)

Total Weight:	30122
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Vehicle Weight & center of gravity (C.G.) for MOBILE MEDICAL UNIT

(Note: Hitch load, if any, doesn't influence C.G. position)

Printout of Load Xpert software

Company:	UNIVERSITY OF ALBERTA	Unit:	FREIGHTLINER M2-106 330WB/239CA SRA (Truck)
Ref.:		Make:	FREIGHTLINER
Date:	MAY 14, 2015	Model #:	M2-106
		Year:	2016
		VIN #:	

Unit (including body, all axles, Accessories (if any) and Loads (if any))			
Weight: 30122 (lb)	CG-X:	197.44 (in)	(measured for trucks & tractors from centerline of steer axle group, for semitrailers from kingpin, for trailers from drawbar eye)
	CG-Y:	-0.73 (in)	(measured from centerline of Unit, negative towards left side)
	CG-Z:	55.65 (in)	(measured from ground)
Chassis (including all axles but without Accessories and Loads)			
Weight: 14315 (lb)	CG-X:	121.26 (in)	(measured for trucks & tractors from centerline of steer axle group, for semitrailers from kingpin, for trailers from drawbar eye)
	CG-Y:	0.00 (in)	(measured from centerline of Unit, negative towards left side)
	CG-Z:	39.79 (in)	(measured from ground)
Overall (Body + Accessories + Loads): 15807 ; 70.02 (in) measured from ground			
Body			
Weight: 9387 (lb)	CG-X:	254.29 (in)	(measured for trucks & tractors from centerline of steer axle group, for semitrailers from kingpin, for trailers from drawbar eye)
	CG-Y:	-4.00 (in)	(measured from centerline of Unit, negative towards left side)
	CG-Z:	75.79 (in)	(measured from ground)
Overall Accessories (all Accessories combined)			
Weight: 6420 (lb)	CG-X:	284.17 (in)	(measured for trucks & tractors from centerline of steer axle group, for semitrailers from kingpin, for trailers from drawbar eye)
	CG-Y:	2.42 (in)	(measured from centerline of Unit, negative towards left side)
	CG-Z:	61.59 (in)	(measured from ground)
Overall Loads (all Loads combined, hitch load not included)			
Weight: 0 (lb)	CG-X:	N/A	(measured for trucks & tractors from centerline of steer axle group, for semitrailers from kingpin, for trailers from drawbar eye)
	CG-Y:	N/A	(measured from centerline of Unit, negative towards left side)
	CG-Z:	N/A	(measured from ground)
Overall Compartments (all compartments combined)			
Weight: 0 (lb)	CG-X:	N/A	(measured for trucks & tractors from centerline of steer axle group, for semitrailers from kingpin, for trailers from drawbar eye)
	CG-Y:	N/A	(measured from centerline of Unit, negative towards left side)
	CG-Z:	N/A	(measured from ground)

CG-X: measured along Vehicle length; CG-Y: measured along Vehicle width; CG-Z: measured along Vehicle height.